







LOCATED IN THE BARLOW MARKET DISTRICT, THE PROPOSED PROJECT IS A MIXED USE 83 ROOM HOTEL IN 4 STORIES WITH A BUILDING HEIGHT OF 50'-0" AND A GROSS FLOOR AREA OF 77,794 SF. INSPIRED BY THE LOCAL WINE COUNTRY'S VERNECULAR ARCHITECTURE, THE BARLOW HOTEL IS FINISHED IN A COMBINATION OF WOOD TONE SIDING, STONE VENEER, METAL PANEL, SMOOTH CONCRETE, AND A STANDING SEAM ROOF. THE BUILDING AMENITY INCLUDES A RESTAURANT, RETAIL, BAR, MEETING ROOMS, A GYM, A SPA AND A ROOFTOP BAR, POOL, AND ROOFDECK FOR HOTEL GUESTS. THE HOTEL ROOMS AND AMENITIES ARE ORGANIZED AROUND CENTRALLY LOCATED LANDSCAPED COURTYARDS AND TUCKED-AWAY PATIOS.

### PROJECT DESCRIPTION

CLIENT:

ALDRIDGE DEVELOPMENT 6780 DEPOT ST SUITE 110 SEBASTOPOL, CA 95472 P: 707-484-8020 CONTACT: BARNEY ALDRIDGE

ARCHITECT:

**BDE ARCHITECTURE** 950 HOWARD STREET SAN FRANCISCO, CA 94103 P: 415.677.0966

**CONTACT: IAN MURPHY** 

LANDSCAPE ARCHITECT:

ZAC LANDSCAPE ARCHITECTS 405 EST D STREET SUITE H PETALUMA, CA 94952 P: 707-696-2967 **CONTACT: SANDRA REED** 

**CIVIL ENGINEER:** 

ADOBE ASSOCIATES 1220 N. DUTTON AVE. SANTA ROSA, CA 95401 P: 707-541-2317 **CONTACT: DAVID BROWN**  TRASH MANAGEMENT:

AMERICAN TRASH **MANAGEMENT** 1900 POWELL ST #220 EMERYVILLE, CA 94608 P: 415-292-5400 CONTACT: DAISY URBINA

### PROJECT TEAM



SITE MAP

**PLANNING & BUILDING CODE SUMMARY** AP0.00 PROJECT INFORMATION AP0.01 STATISTICS ZONING: CM AP0.02 SITE CIRCULATION PLAN PERSPECTIVE VIEW AP0.03 HEIGHT / BULK: 50'-0" (W. C.U.P. APPROVAL)/4 STORIES AP0.04 PERSPECTIVE VIEW AP0.05 **EXISTING SITE CONDITIONS** SETBACKS: AP0.06 AREA DEVELOPMENT PLAN FRONT: 15'-0" MIN. AP0.07 **EXISTING & PROPOSED ELEVATIONS** SIDES: 0'-0" MIN. AP0.08 **EXISTING & PROPOSED ELEVATIONS** REAR: 0'-0" MIN. AP0.09 **EXISTING & PROPOSED ELEVATIONS** AP0.10 **EXISTING & PROPOSED ELEVATIONS** PROVIDED: AP0.11 SPLIT LEVEL DIAGRAM FRONT: 15'-3" (PROVIDED TO FACE OF CURB) (SEBASTOPOL AVE.) **GRADING & DRAINAGE PLAN (HOTEL)** C1.0 SIDES: 0'-0" (PROVIDED) C2.0 UTILITY PLAN REAR: 14'-6" (PROVIDED TO FACE OF CURB) C3.0 **EXISTING EASEMENT EXHIBIT** C3.1 PROPOSED/MODIFIED EASEMENT EXHIBIT PROJECT LOCATION: 6782 SEBASTOPOL AVE., SEBASTOPOL, CA 95472 C3.2 PROPERTY LINE EXHIBIT C4.0 **GRADING & DRAINAGE PLAN (PARKING LOT)** APN: 004750-030 AP1.00 SITE PLAN - FLOOR 1 FEMA FLOOD ZONE: ΑE AP1.01 SITE PLAN - ROOF LOT AREA: 50,530 SF (1.16 ACRE) AP2.01 **BUILDING PLAN - FLOOR 1** AP2.02 **BUILDING PLAN - FLOOR 2 GROSS FLOOR AREA:** 82.275 SF **BUILDING PLAN - FLOOR 3** AP2.03 **NET FLOOR AREA:** GSF X .85 (PER CITY DEFINITION): 69,934 SF **BUILDING PLAN - ROOF** AP2.04 FLOOR AREA RATIO: .47 AP3.00 **ELEVATIONS** AP3.01 **ELEVATIONS** 83 **HOTEL ROOMS:** AP3.10 MATERIAL BOARD AP3.20 SECTIONS **PARKING** AP3.21 **SECTIONS** VEHICLE PARKING REQUIRED: 78 SPACES AP4.00 **GUEST ROOM PLANS** VEHICLE PARKING PROPOSED: L1.0 LANDSCAPE SITE PLAN MARKET/HOTEL: 73 SPACES LANDSCAPE COURTYARD PLAN L1.01 BATCH PARKING LOT: 232 SPACES' LANDSCAPE ROOF PLAN L1.1 TOTAL: 305 SPACES L2.0 PLANTING SITE PLAN L2.1 PLANT LEGENDS \* 126 SPACES AT BATCH ARE DESIGNATED VALET L2.2 PLANT IMAGES L3.0 BATCH PLANT PARKING SITE PHOTOS **BICYCLE PARKING REQUIRED: 12 SPACES** L3.1 BATCH PLANT PARKING LANDSCAPE PLAN L3.2 BATCH PLANT PARKING LANDSCAPE SECTIONS BICYCLE PARKING PROPOSED: L3.3 BATCH PLANT PARKING MORRIS STREETSCAPE CLASS II SPACES: 20 SPACES L3.4 BATCH PLANT PARKING PRECEDENT IMAGES L4.0 BATCH PLANT PARKING PLANTING PLAN **BUILDING DATA** L4.1 BATCH PLANT PARKING PLANT LEGENDS L5.0 BATCH PLANT PARKING LIGHTING PLAN

STORIES: 4 STORIES

**BUILDING HEIGHT:** 55'-0" T.O. UPPER ROOF

**BUILDING USE:** HOTEL (TRANSIENT RESIDENTIAL) **OCCUPANCY TYPE:** R-1. B. A-3. K. S-1. M

PRIVATE OPEN SPACE: 9,638 SF PUBLIC OPEN SPACE: 2,261 SF

PROJECT SUMMARY

SHEET INDEX 1

PROJECT INFORMATION

AP0.00

(A)

ALDRIDGE

adobe associates, inc.

SEBASTOPOL. CA **DECEMBER 20, 2024** 

**BATCH PLANT STORAGE SHED** 

TRASH COLLECTION AREA

FLOOR 1 - PLAN

STAGING AREA

SECTIONS

L6.0

T0.1

T1.0

T1.1

T1.2

**GUESTROOM AND AREA SUMMARY** 

PROJECT NAME: THE BARLOW HOTEL PROJECT LOCATION: SEBASTOPOL, CA LATEST UPDATE: **DECEMBER 20, 2024** 

CONSTRUCTION TYPE: TYPE III-A FLOORS: 3 WOOD

GUESTROOM	TYPE	DESCRIPTION	GUESTROOM					GUESTROOM	% RATIO	TOTAL GUESTROOM AREA (SF)
			AREA (SF)	1ST	2ND	3RD	ROOF	TOTAL		` ,
QUEEN	Q1.0	STANDARD QUEEN	290	-	2	2	-	4	5%	1,161
	DQ1.0	DOUBLE QUEEN	369	-	3	1	-	4	5%	1,475
	DQ2.0	DOUBLE QUEEN	397	-	2	-	-	2	2%	794
	DQ3.0	DOUBLE QUEEN	409	-	2	2	-	4	5%	1,635
QUEEN SUB-TOTAL		AVERAGE SF	362	-	9	5	-	14	17%	5,065
KING	K1.0	STANDARD KING	295	-	3	-	-	3	4%	884
	K2.0	STANDARD KING	296	-	12	12	-	24	29%	7,098
	K3.0	STANDARD KING	369	-	1	-	-	1	1%	369
	DK1.0	DELUXE KING	319	-	4	4	-	8	10%	2,555
	DK2.0	DELUXE KING	327	2	3	3	-	8	10%	2,619
	DK3.0	DELUXE KING	340	2	3	-	-	5	6%	1,699
	DK4.0	DELUXE KING	369	-	3	1	-	4	5%	1,475
	DK5.0	DELUXE KING	376	1	1	-	-	2	2%	752
	DK6.0	DELUXE KING	409	-	1	1	-	2	2%	817
	DK7.0	DELUXE KING	484	-	-	1	-	1	1%	484
	DK8.0	DELUXE KING	508	-	-	1	-	1	1%	508
	DK9.0	DELUXE KING (DOUBLE)	544	-	2	1	-	3	4%	1,633
KING SUB-TOTAL		AVERAGE SF	337	5	33	24	-	62	75%	20,892
SUITE	S1.0	JUNIOR SUITE	400	-	1	-	-	1	1%	400
	S2.0	JUNIOR SUITE	550	-	2	2	-	4	5%	2,202
	S3.0	JUNIOR SUITE	657	-	1	-	-	1	1%	657
	S4.0	JUNIOR SUITE	695	-	1	-	-	1	1%	695
SUITE SUB-TOTAL		AVERAGE SF	565	-	5	2	-	7	8%	3,954
TOTAL GUESTROOM		AVERAGE SF	360	5	47	31	-	83	100%	29,911

NET RENTABLE TRANSIENT RESIDENTIAL AREA IS MEASURED CENTER OF DEMISING WALL, EXTERIOR FACE OF STUD OF EXTERIOR WALL AND CORRIDOR WALLS, EXCLUDING DECKS


NET RENTABLE TRANSIENT RESIDENTIAL BY FLOOR (EXCLUDING DECKS)	1,710	17,212	10,989	0	29,911
HOTEL AMENITIES (GYM, ROOF DECK)	557	-	-	8,452	9,009
LEASING OFFICE (ADMIN, MEETING ROOM, BREAKOUT ROOM, CONFERENCE)	3,468	-	-	-	3,468
COMMERCIAL (RESTAURANT, BAR, RETAIL, SPA)	5,966	-	-	-	5,966
OPEN SPACE (COURTYARDS, PATIOS, POOL AREA)	6,044	570	-	-	6,615
OTHER (BOH, UTILITY ROOMS, CIRCULATION, SHAFTS)	13,295	7,060	5,035	1,916	27,306
TOTAL GROSS	31,040	24,842	16,025	10,368	82,275

**STATISTICS** 








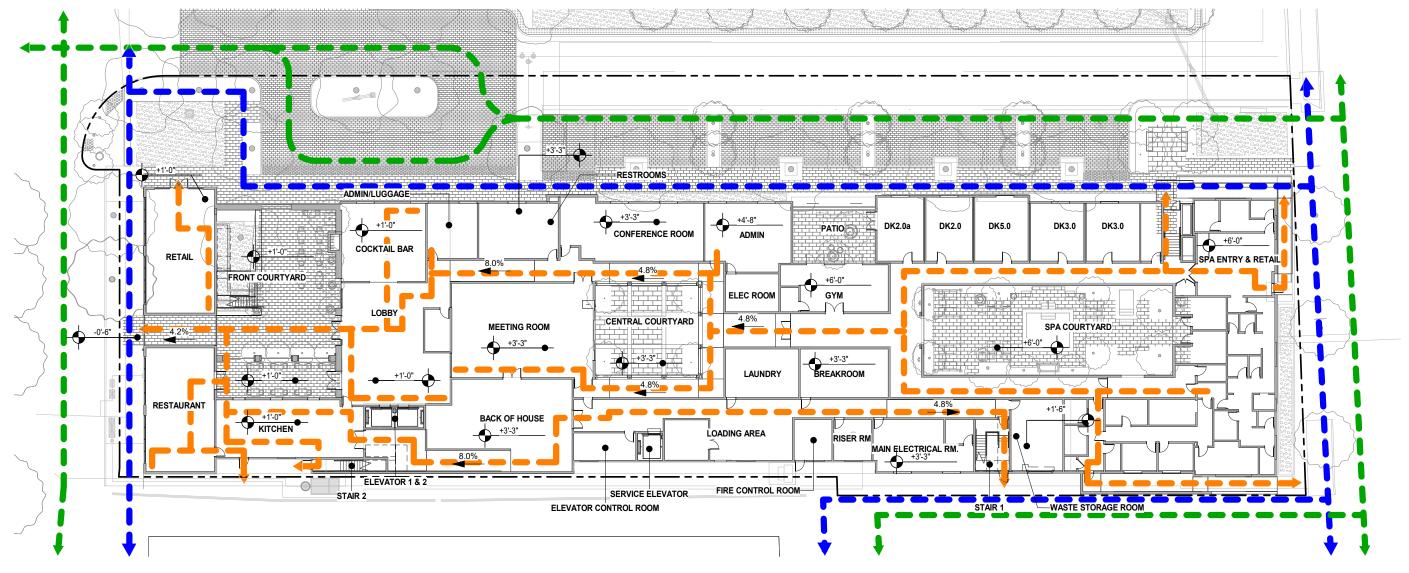

## **CIRCULATION LEGEND**

**EGRESS PATH** PUBLIC PEDESTRIAN PATH **VEHICULAR CIRCULATION** 

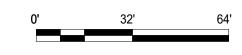

SEBASTOPOL, CA



1/32"=1'-0"



















AP0.03

SEBASTOPOL, CA






















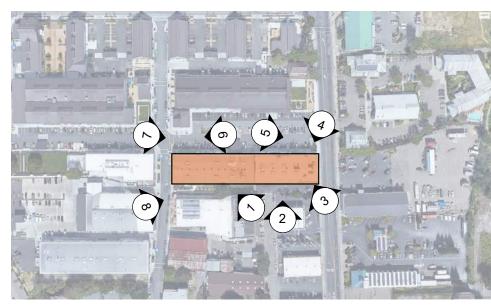









**EXISTING SITE CONDITIONS** 













o'-0" AP0.06












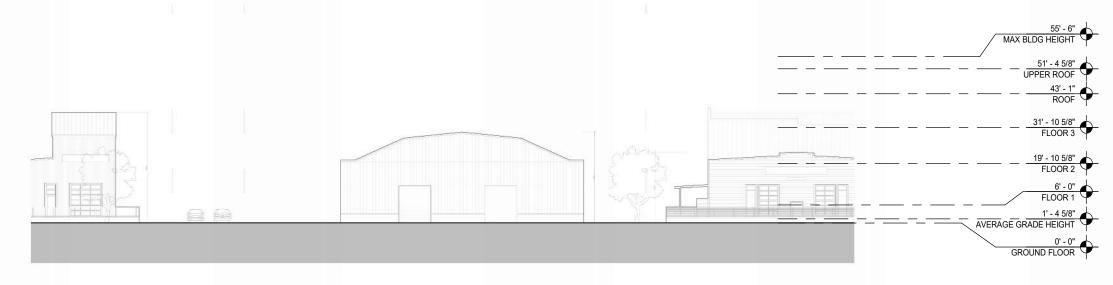

# **EXISTING ELEVATION - MCKINLEY ST 2**

1/32" = 1'-0"



## PROPOSED ELEVATION - MCKINLEY ST 1

1/32" = 1'-0"



**EXISTING AND PROPOSED ELEVATIONS** 

1/32"=1'-0"

AP0.07










THE BARLOW HOTEL

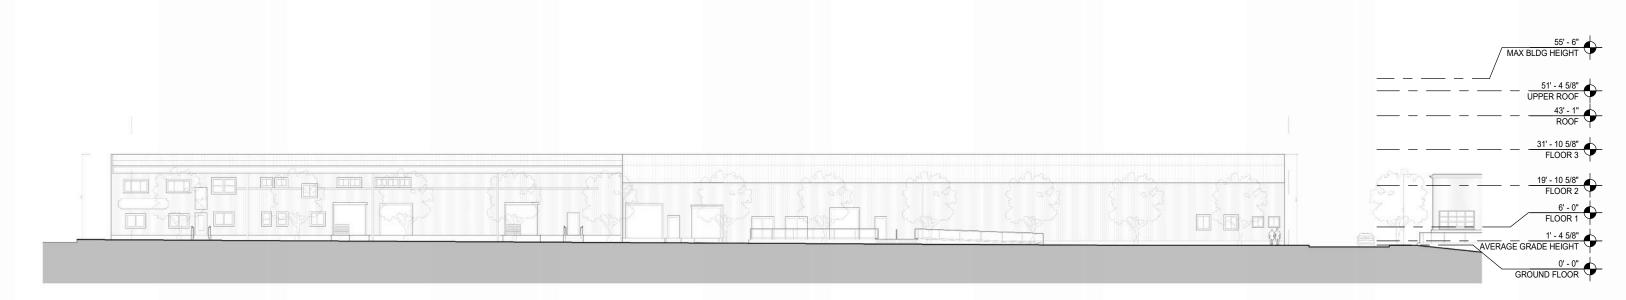

# **EXISTING ELEVATION - GRAVENSTEIN COURT 2**

1/32" = 1'-0"



## PROPOSED ELEVATION - GRAVENSTEIN COURT 1

1/32" = 1'-0"



**EXISTING AND PROPOSED ELEVATIONS** 

1/32"=1'-0"









## **EXISTING ELEVATION - SEBASTOPOL AVE. 2**

1/32" = 1'-0"



## PROPOSED ELEVATION - SEBASTOPOL AVE. 1

1/32" = 1'-0"



**EXISTING AND PROPOSED ELEVATIONS** 

1/32"=1'-0"

AP0.09









# EXISTING ELEVATION - DEPOT ST 2

1/32" = 1'-0"



THE BARLOW HOTEL

## PROPOSED ELEVATION - DEPOT ST 1

1/32" = 1'-0"




**EXISTING AND PROPOSED ELEVATIONS** 

1/32"=1'-0"







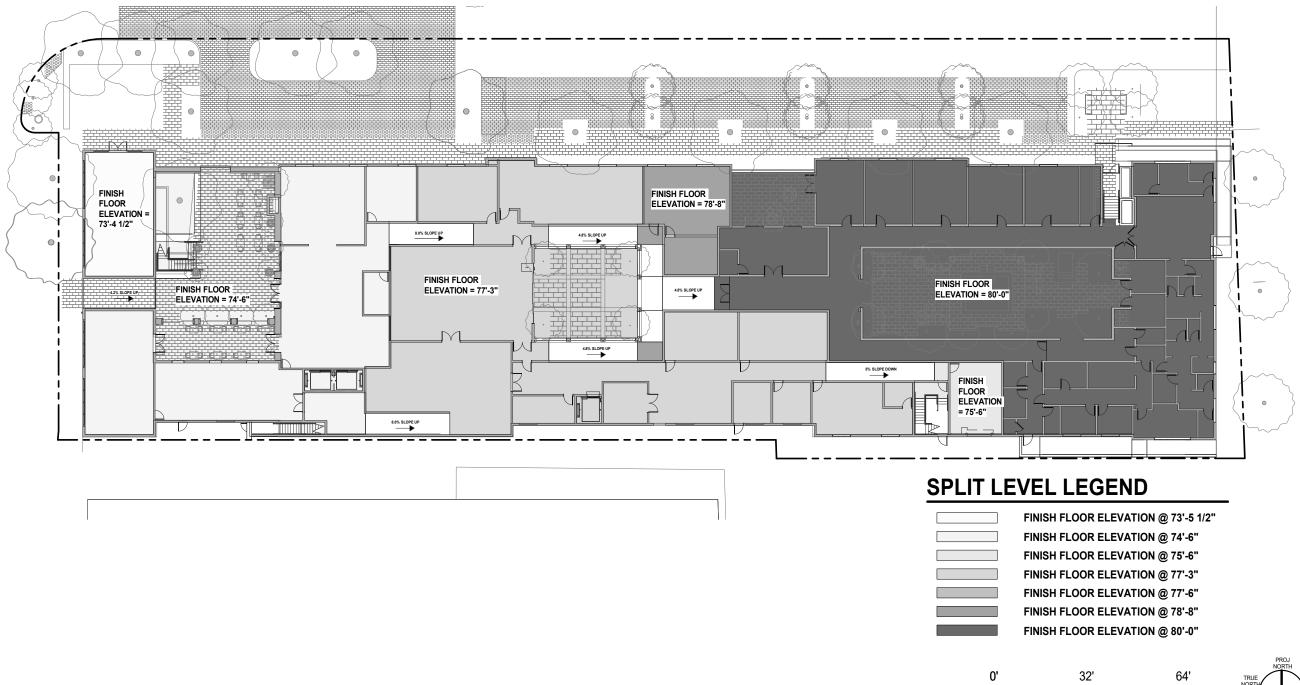













1/32"=1'-0" **AP0.11** 

SEBASTOPOL, CA








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**GRADING & DRAINAGE** PLAN (HOTEL)

PROJ. # 24174 DRAWN BY RMS SHEET SIZE





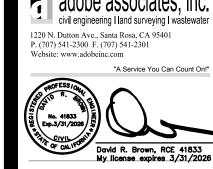

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UTILITY PLAN (HOTEL)

PROJ. # 24174 DRAWN BY RMS SHEET SIZE





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**EXISTING EASEMENT** 

PROJ.# 24174 DRAWN BY RMS SHEET SIZE










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PROPOSED/MODIFIED **EASEMENT EXHIBIT** 

PROJ.# 24174 DRAWN BY RMS SHEET SIZE




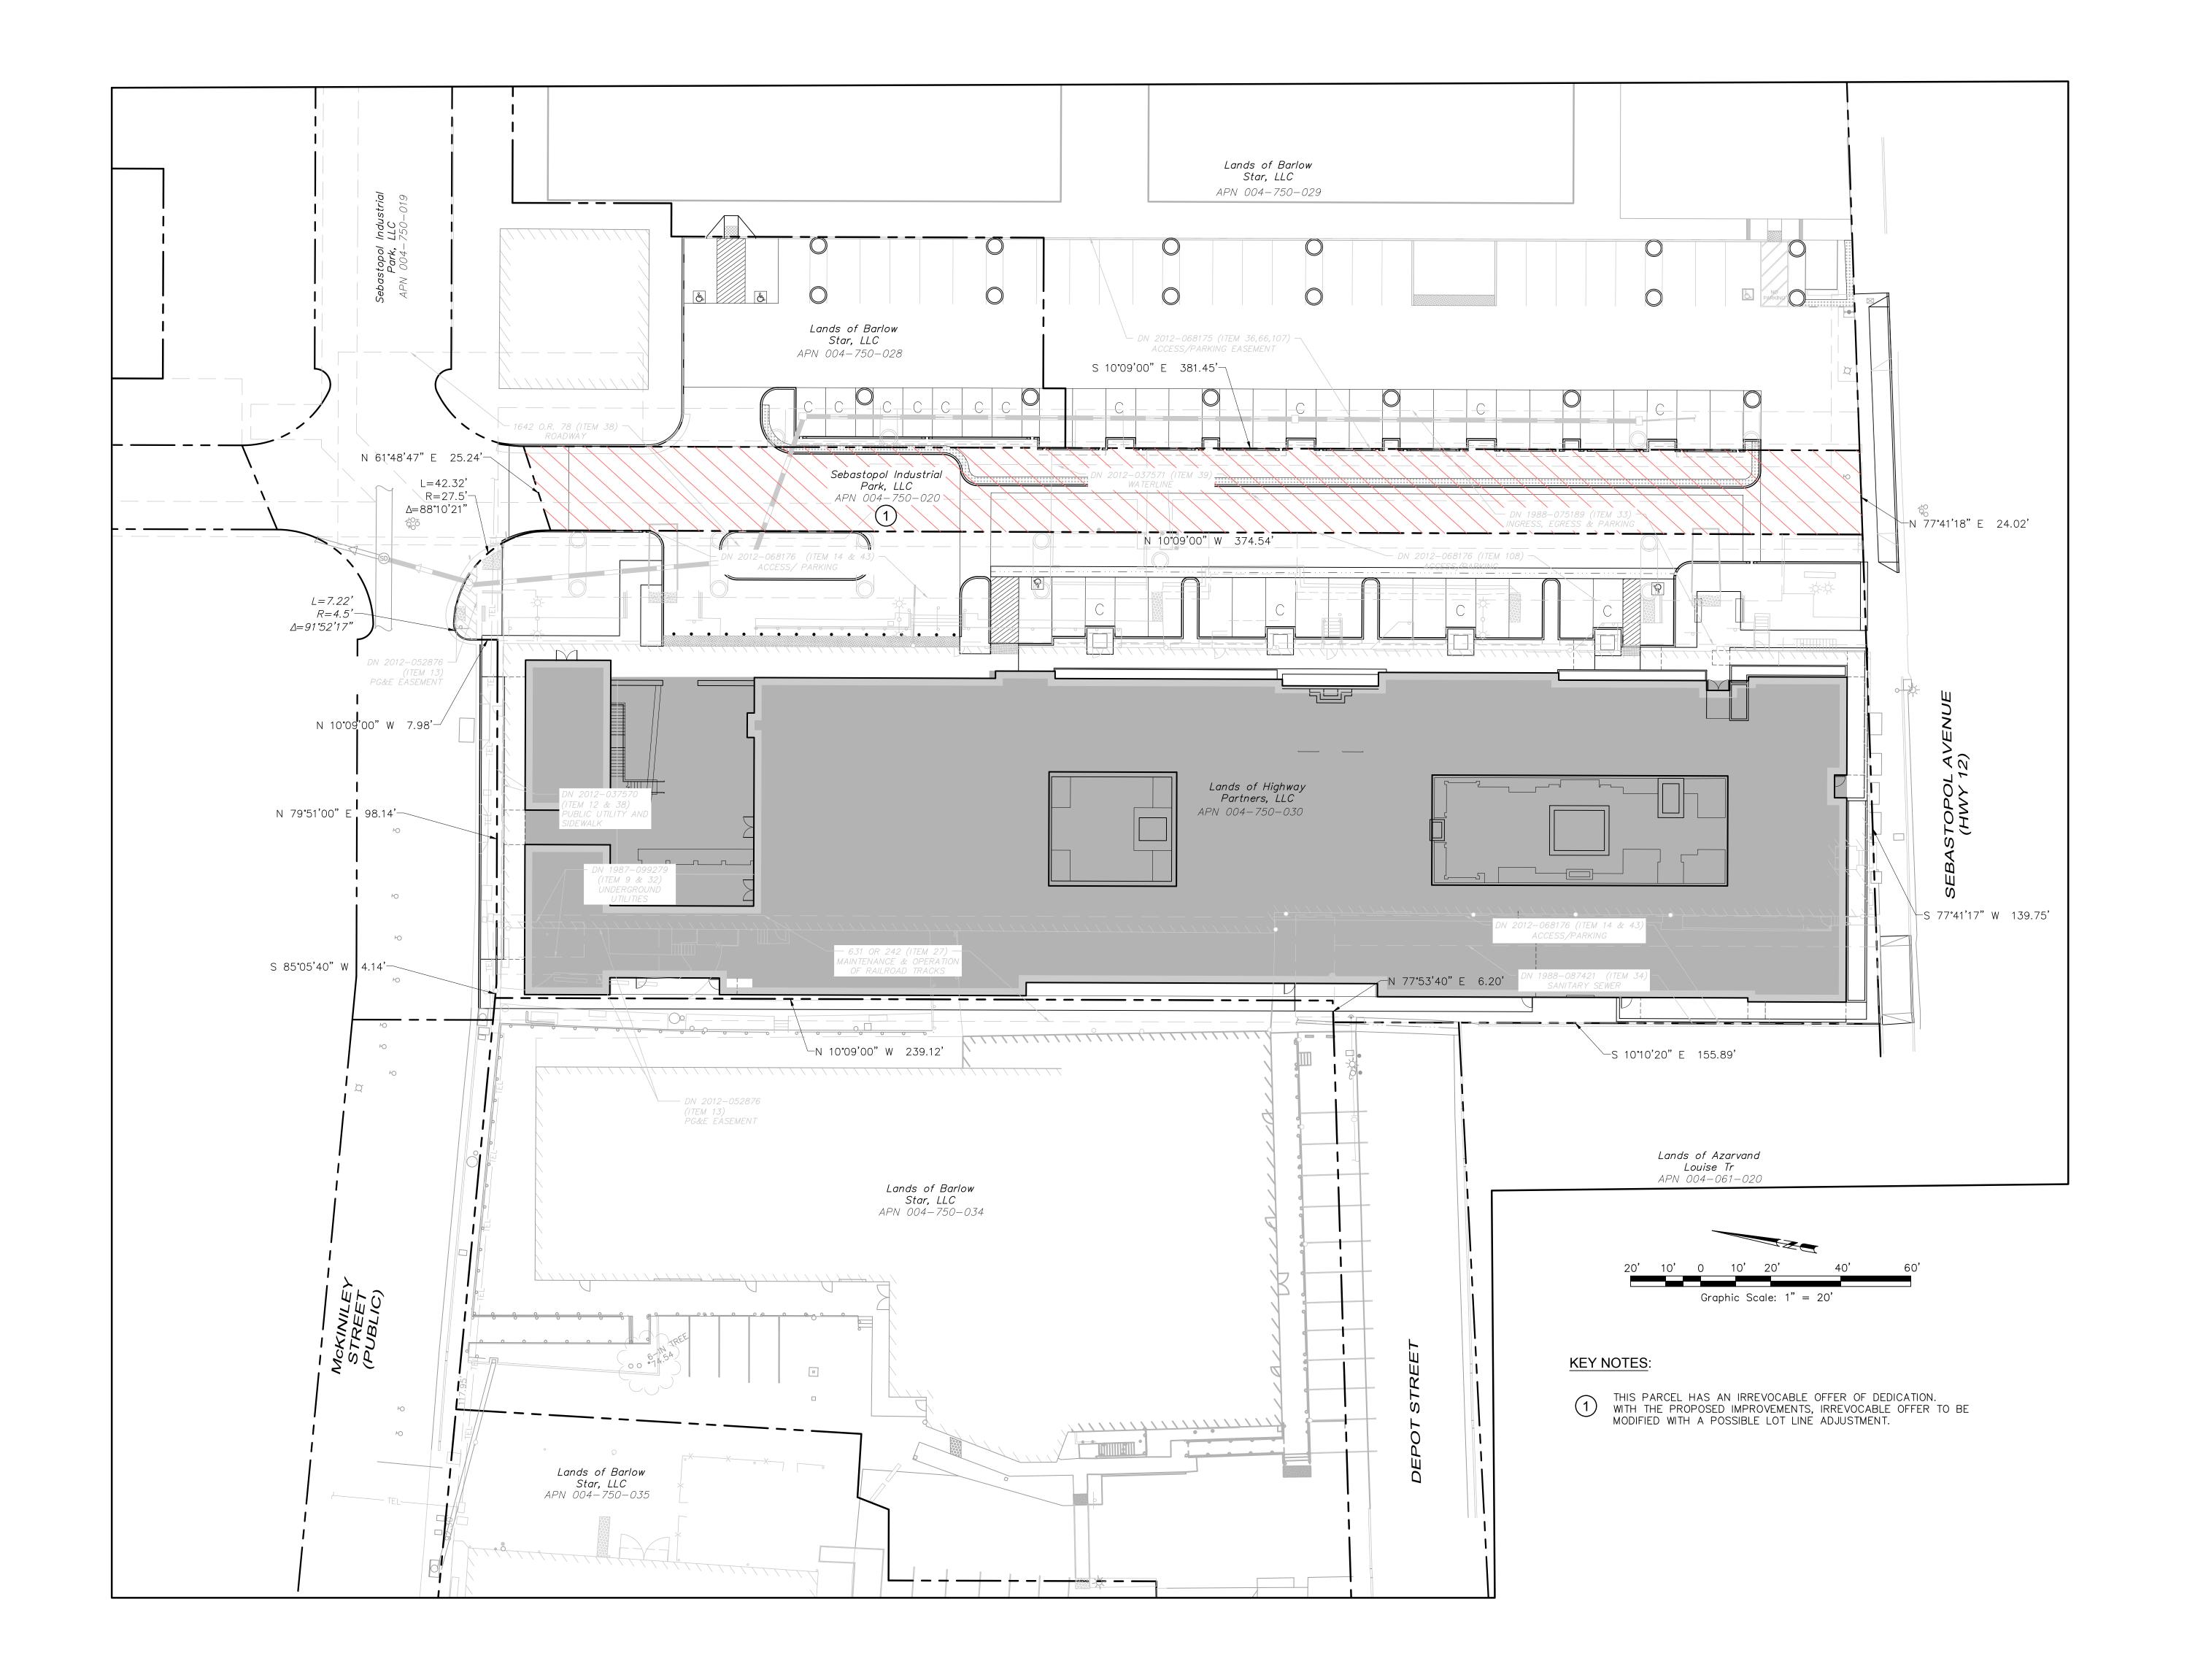







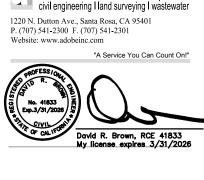

REV ISSUE

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PROJ.# 24174 DRAWN BY RMS







**Overflow Commerical Parking** 

Stall Type

Regular Space (Non EV) (19' X 9')

ADA Access Standard (19' X 10')

ADA Access Van (19' X 9')

Vallet Parking (EV) (23.4' X 8.5')

ADA Access Van (EV) (18' X 12')

Compact (16' X 9')

Vallet Parking (Compact 16' X 9') (Reg

8.5' X 19')

**Total Stalls** 

**Parking Count** 

110

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**GRADING AND DRAINAGE PLAN** (PARKING LOT)

PROJ.# 24174 DRAWN BY RMS SHEET SIZE

<u>HATCHING LEGEND</u>:

TI=5, 2.5" AC OVER 6" CL II AB

BIO-RETENTION AREA


PRELIMINARY GRADING QUANTITIES:

CUT= 1677 CU YDS

FILL= 1601 CU YDS

PAVEMENT AS ALLOWED BY CITY OF SEBASTOPOL CODE SECTION 15.90.030-15.90.070.


THE GRADING QUANTITY IS CALCULATED FROM EXISTING GRADE TO THE SUBGRADE SECTION OF THE

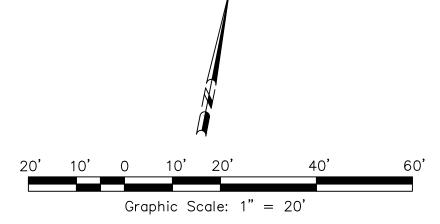

Batch Plant Parking Count					
Stall Type	Parking Count				
Regular Space (Non EV) (19' X 9')	95				
ADA Access Standard (19' X 10')	4				
ADA Access Van (19' X 9')	1				
Vallet Parking (EV) (23.4' X 8.5')	18				
ADA Access Van (EV) (18' X 12')	1				
Compact (16' X 9')	5				
Vallet Parking (Compact 16' X 9') (Reg					
8.5' X 19')	108				
Total Stalls	232				

Hotel Employee Parking				
Parking Count				
54				
2				
1				
12				
1				
70				

Hotel Guest Parking						
Stall Type	Parking Count					
Vallet Parking (Compact 16' X 9') (Reg 8.5' X 19')	52					

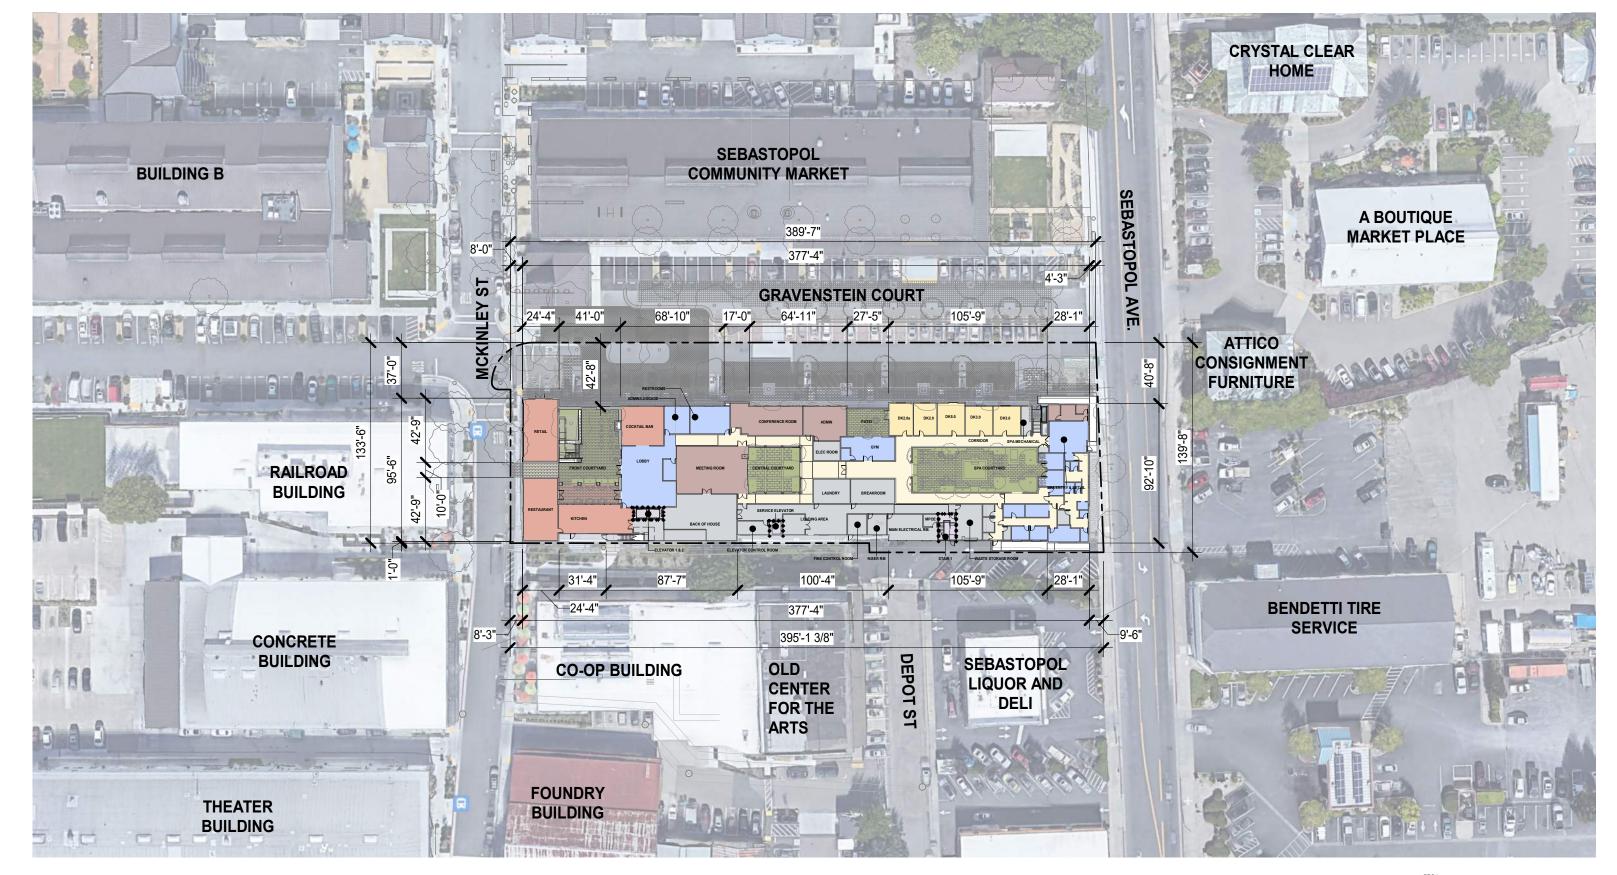

THE BARLOW HOTEL





O" AP1.01













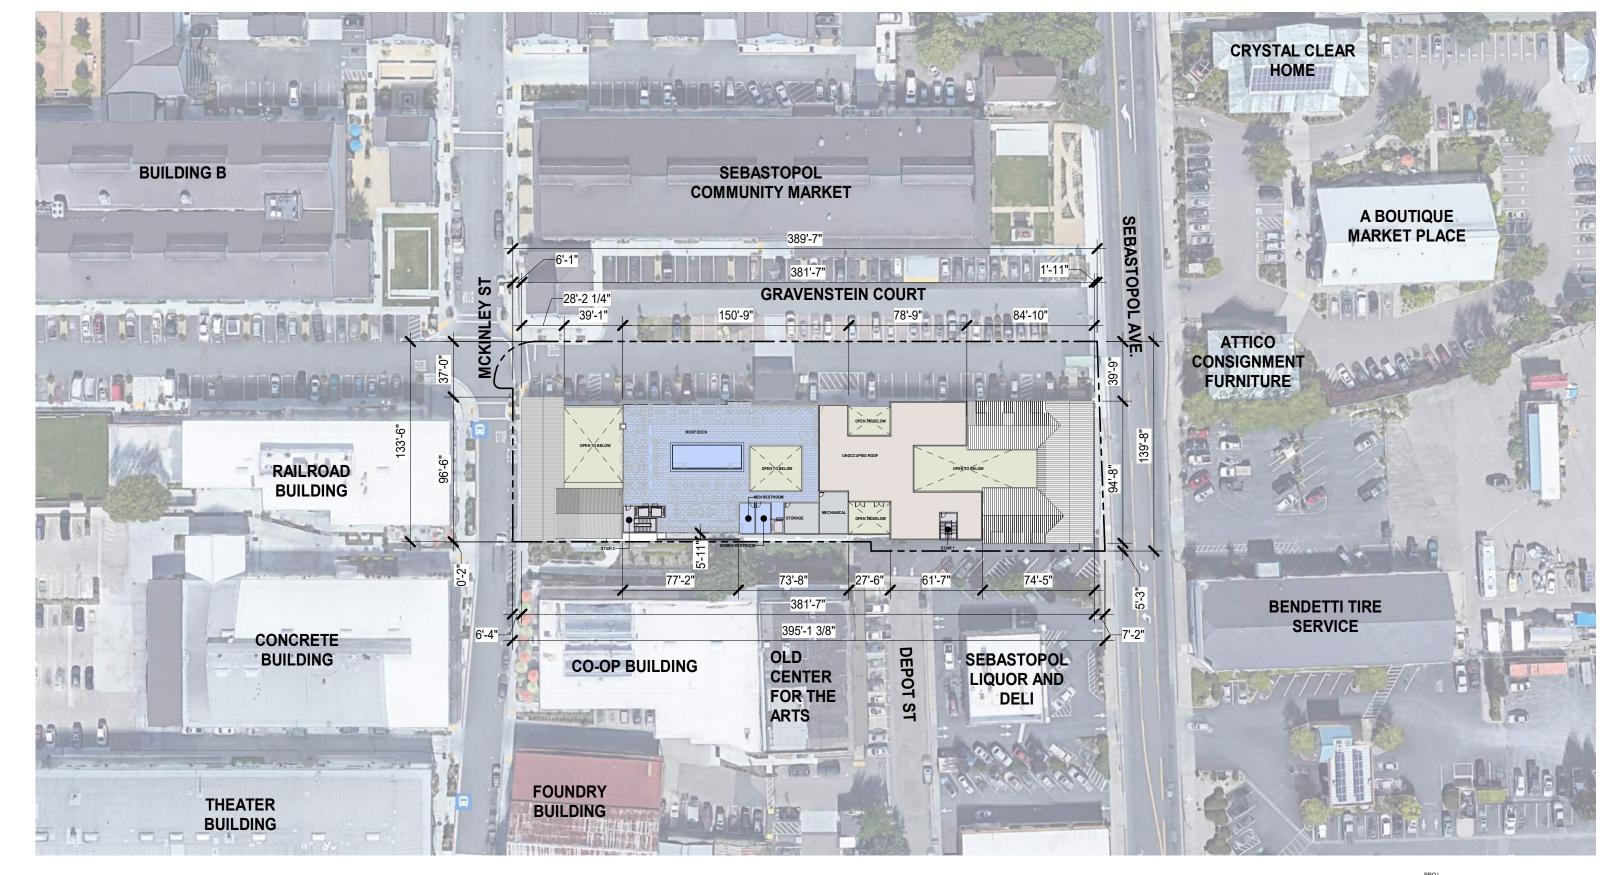

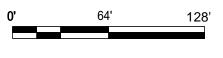

**SITE PLAN - ROOF** 




AP1.02










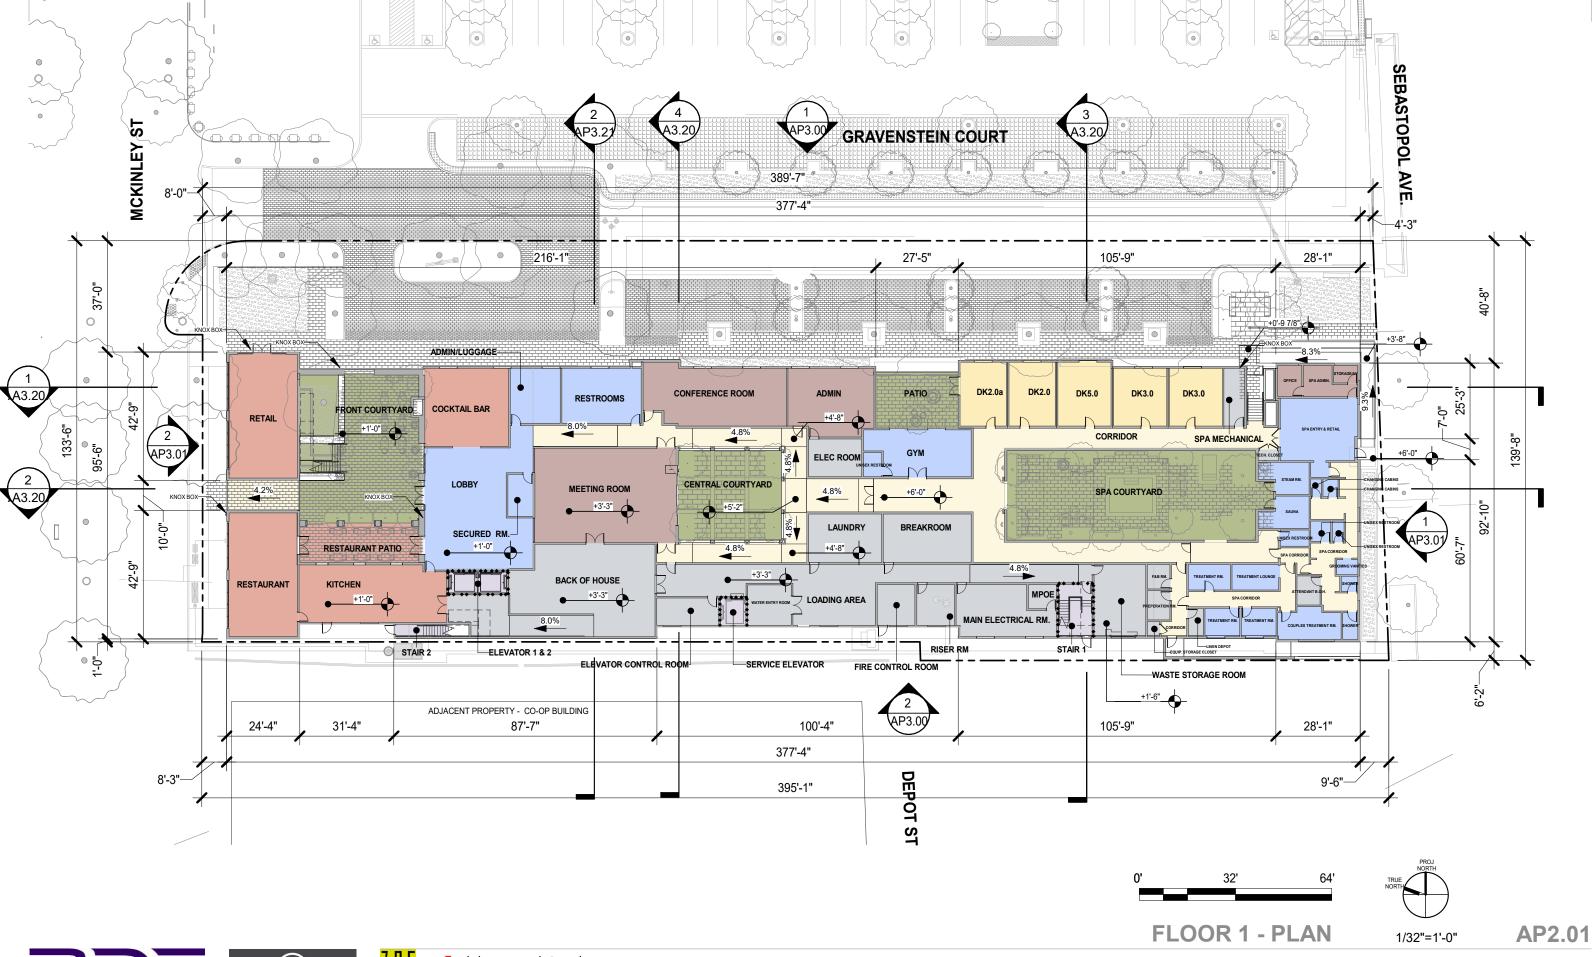








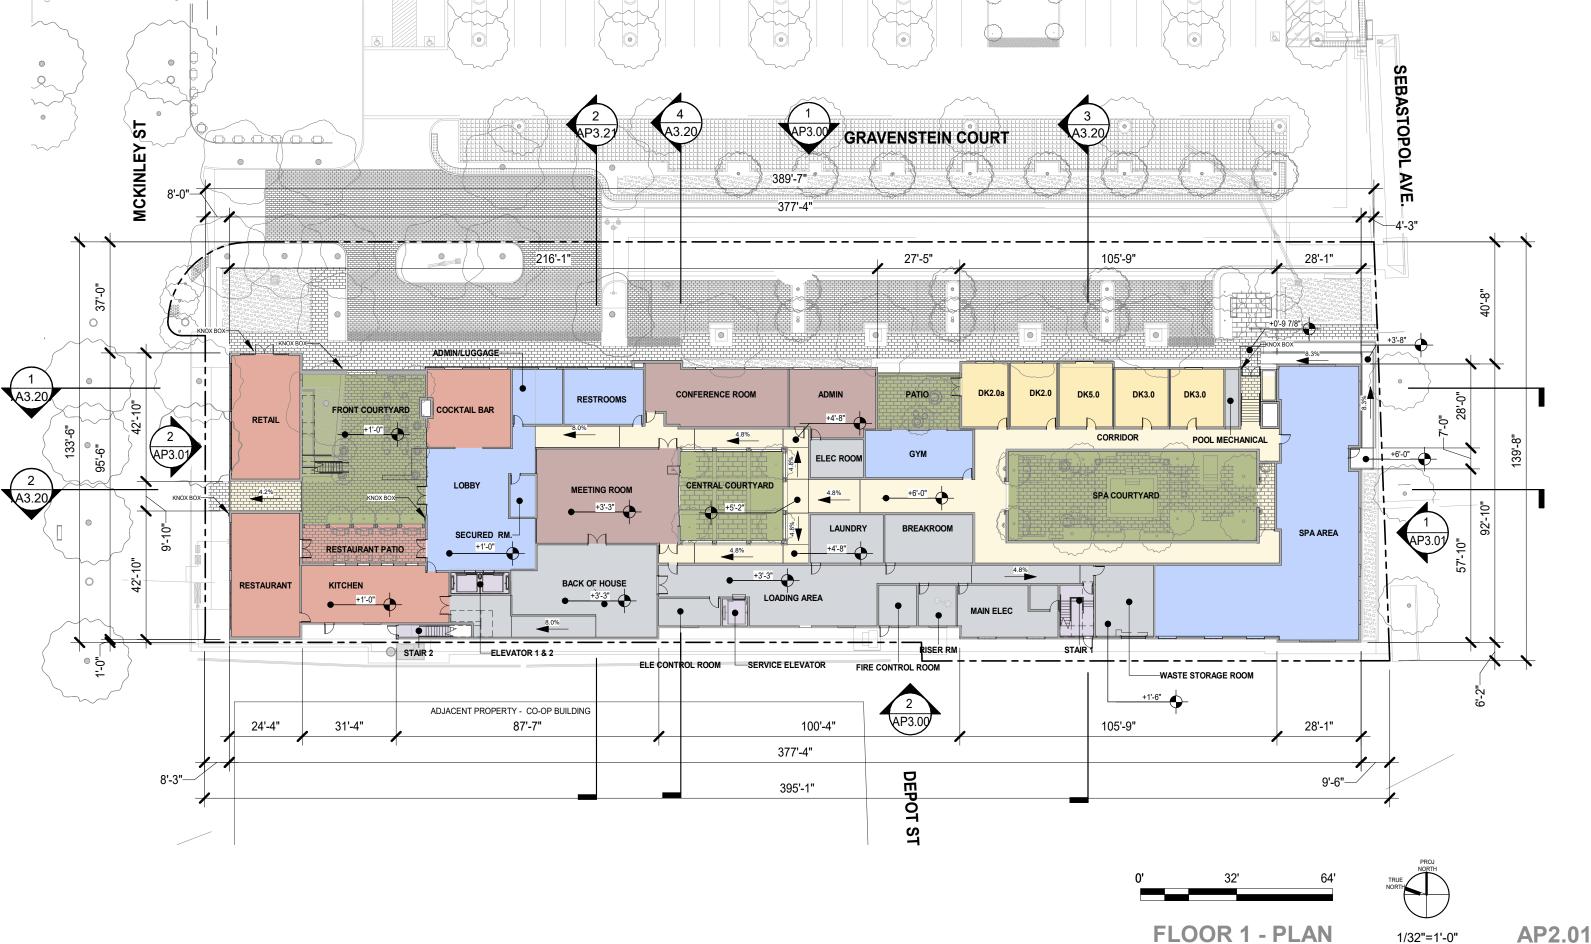








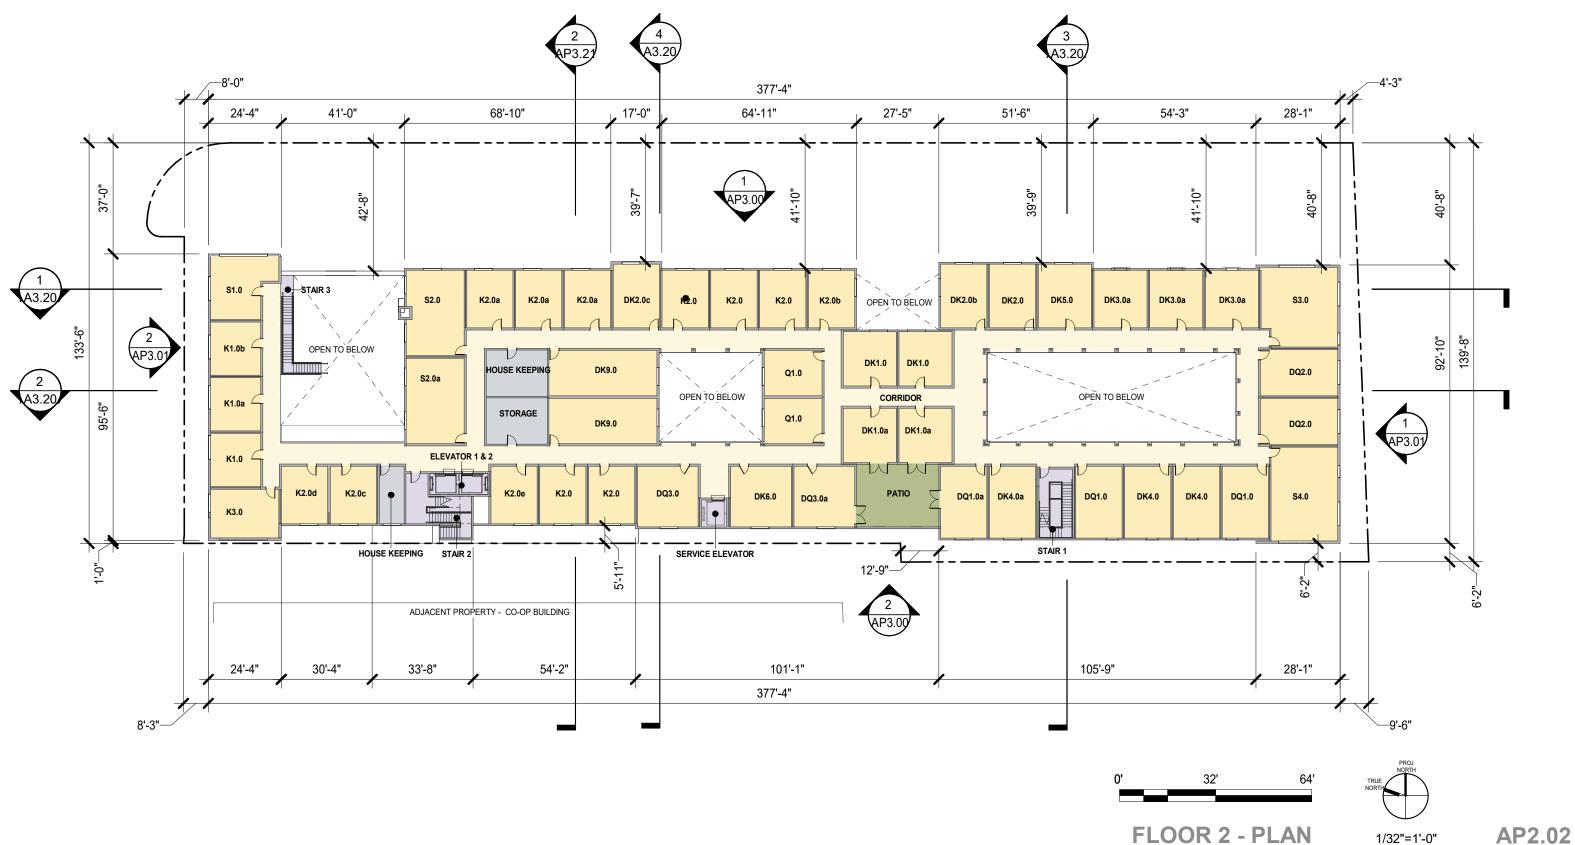







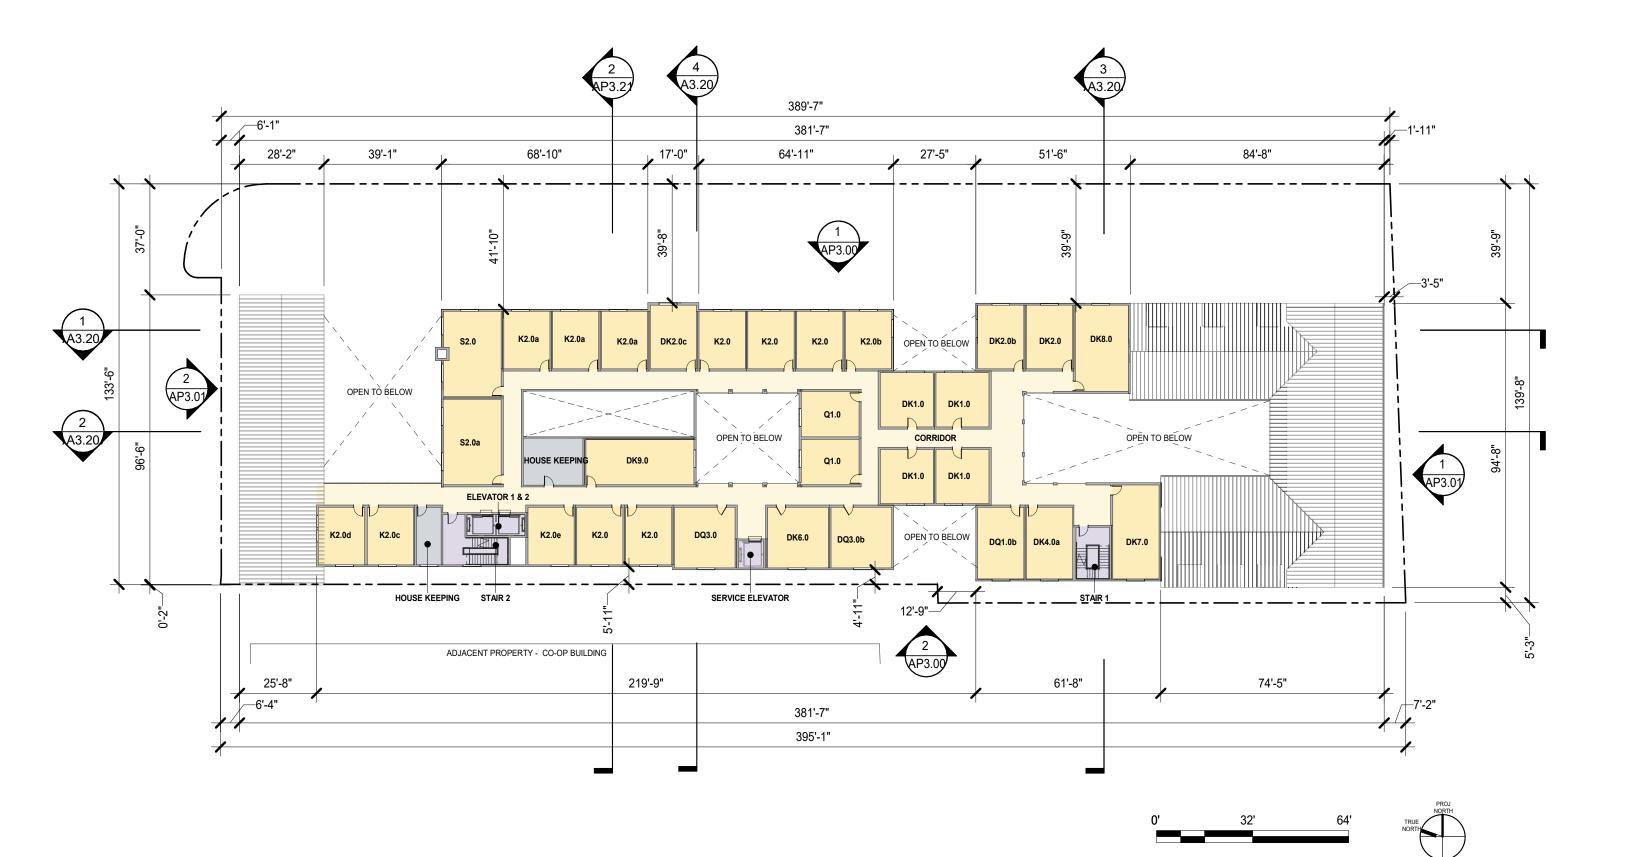












SEBASTOPOL, CA

AP2.03

**DECEMBER 20, 2024** 

1/32"=1'-0"

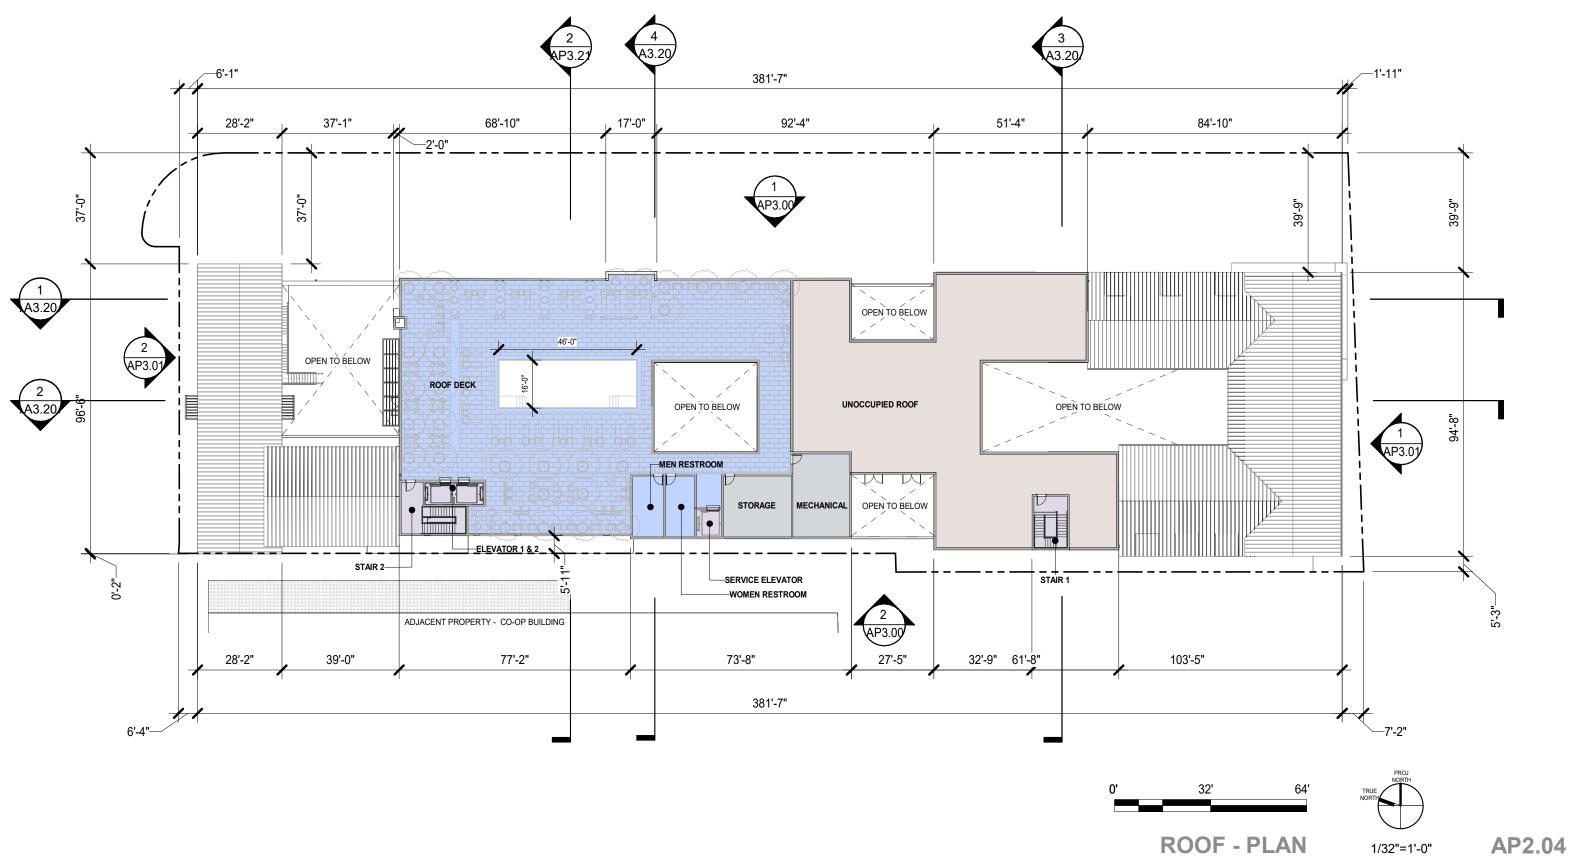










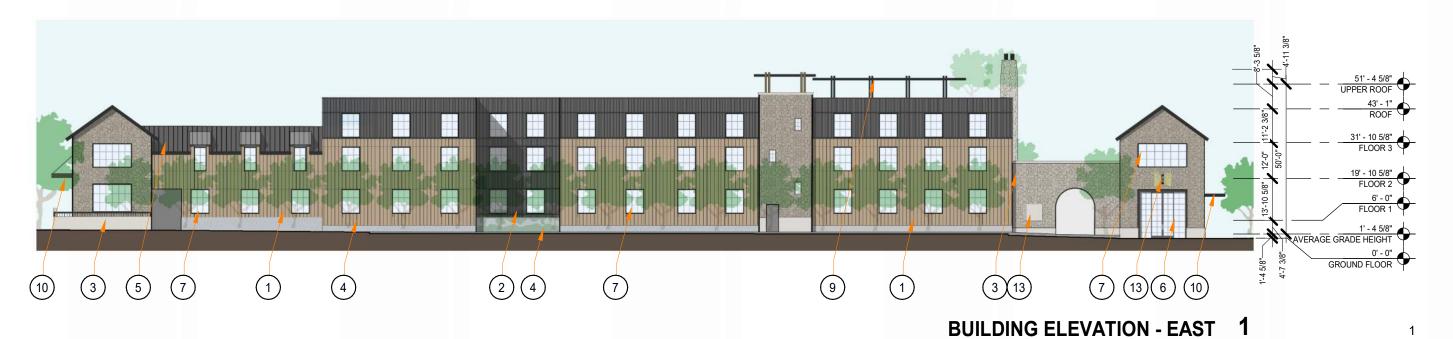

#### MATERIAL SHEET NOTE

- WOOD TONE SIDING
- METAL PANEL SIDING
- STONE VENEER
- SMOOTH CONCRETE
- STANDING SEAM ROOF
- GLAZING
- ALUMINUM/VINYL WINDOW
- - METAL RAILING
  - WOOD/METAL TRELLIS
- METAL AWNING
- TUMBLED STONE PAVER
- (13) SIGNAGE
- OVERHEAD DOOR
- PAVING-WASHED CONCRETE



**ELEVATIONS** 

1/32" = 1'-0"


1/32"=1'-0"

**AP3.00** 







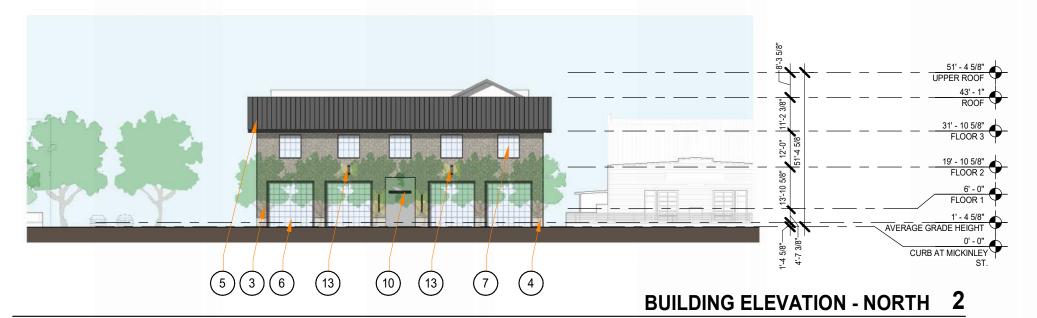

1/32" = 1'-0"



#### MATERIAL SHEET NOTE


- WOOD TONE SIDING
- METAL PANEL SIDING
- STONE VENEER
- SMOOTH CONCRETE
- STANDING SEAM ROOF
- GLAZING
- ALUMINUM/VINYL WINDOW
- METAL RAILING
- WOOD/METAL TRELLIS
- METAL AWNING
- TUMBLED STONE PAVER
- OVERHEAD DOOR

SIGNAGE

PAVING-WASHED CONCRETE



**ELEVATIONS** 

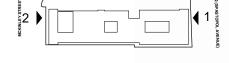

1/32"=1'-0"

**AP3.01** 












(13)

1/32" = 1'-0"



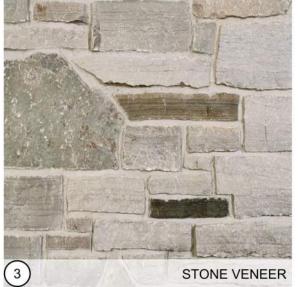












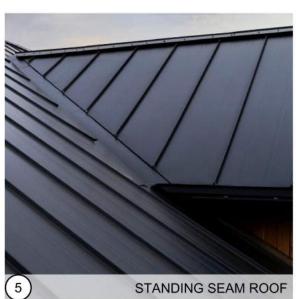



THE BARLOW HOTEL










**AP3.10** 










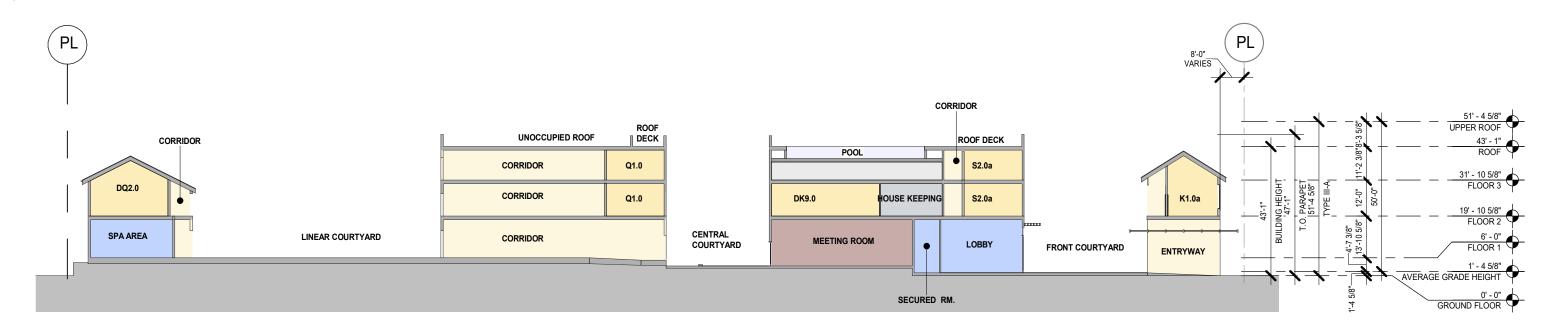

## BUILDING SECTION - NORTH/SOUTH 2


1/32" = 1'-0"

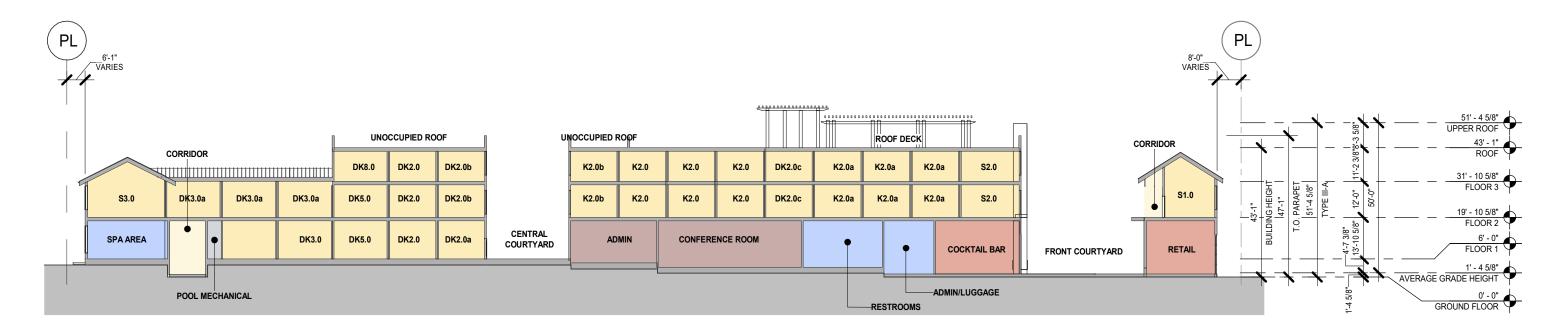

THE BARLOW HOTEL

### **BUILDING SECTION - NORTH/SOUTH**

1/32" = 1'-0"

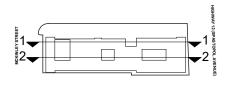




SECTIONS

1/32"=1'-0" **AP3.20** 








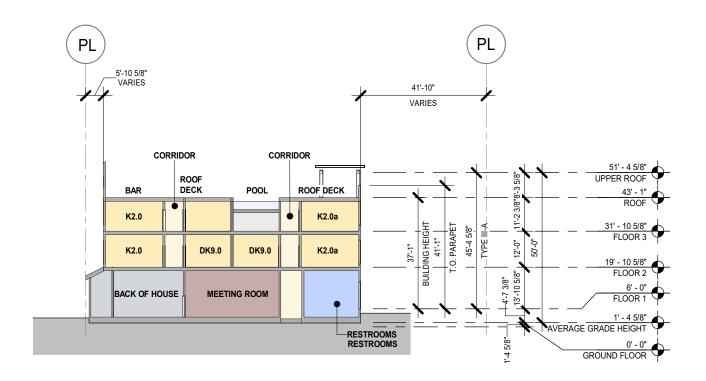

## **BUILDING SECTION - EAST/WEST 2**

1/32" = 1'-0"

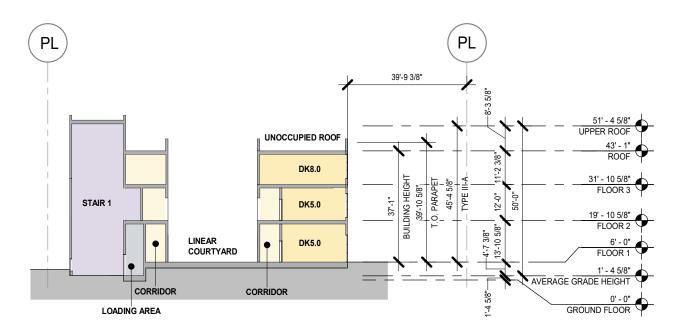


## **BUILDING SECTION - EAST/WEST 1**

THE BARLOW HOTEL

1/32" = 1'-0"



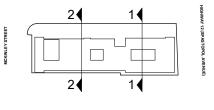

SECTIONS


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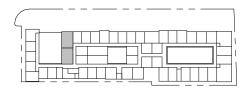
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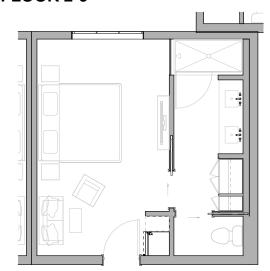










**KEY PLAN - FLOOR 2-3** 

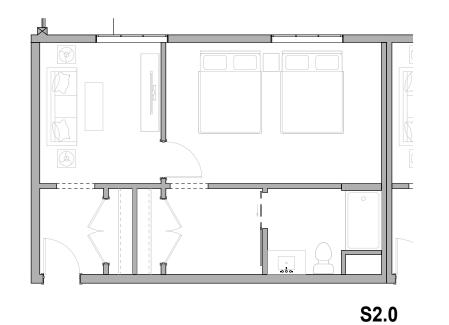


DK1.0

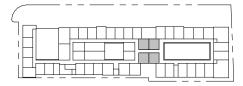


**KEY PLAN - FLOOR 2-3** 

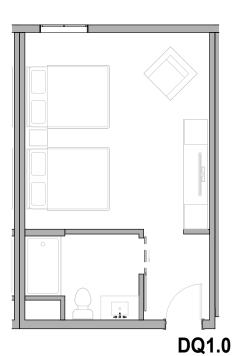

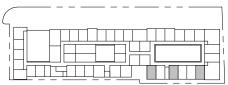


**KEY PLAN - FLOOR 1-3** 

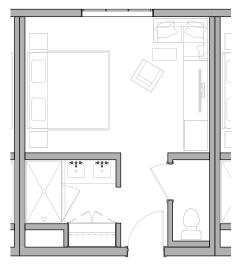





**KEY PLAN - FLOOR 1-3** 

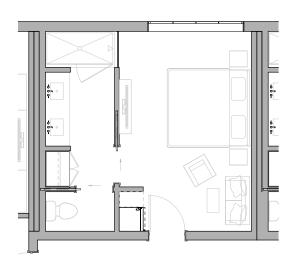


K1.0

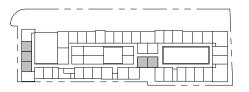

**KEY PLAN - FLOOR 1-3** 

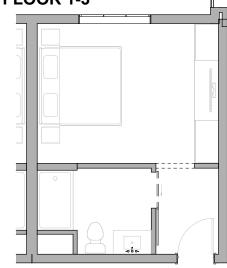

Q1.0

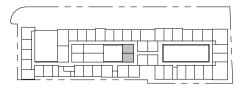

**KEY PLAN - FLOOR 2-3** 



**GUEST ROOM PLANS** 

1/8"=1'-0"

**AP4.00** 










K2.0

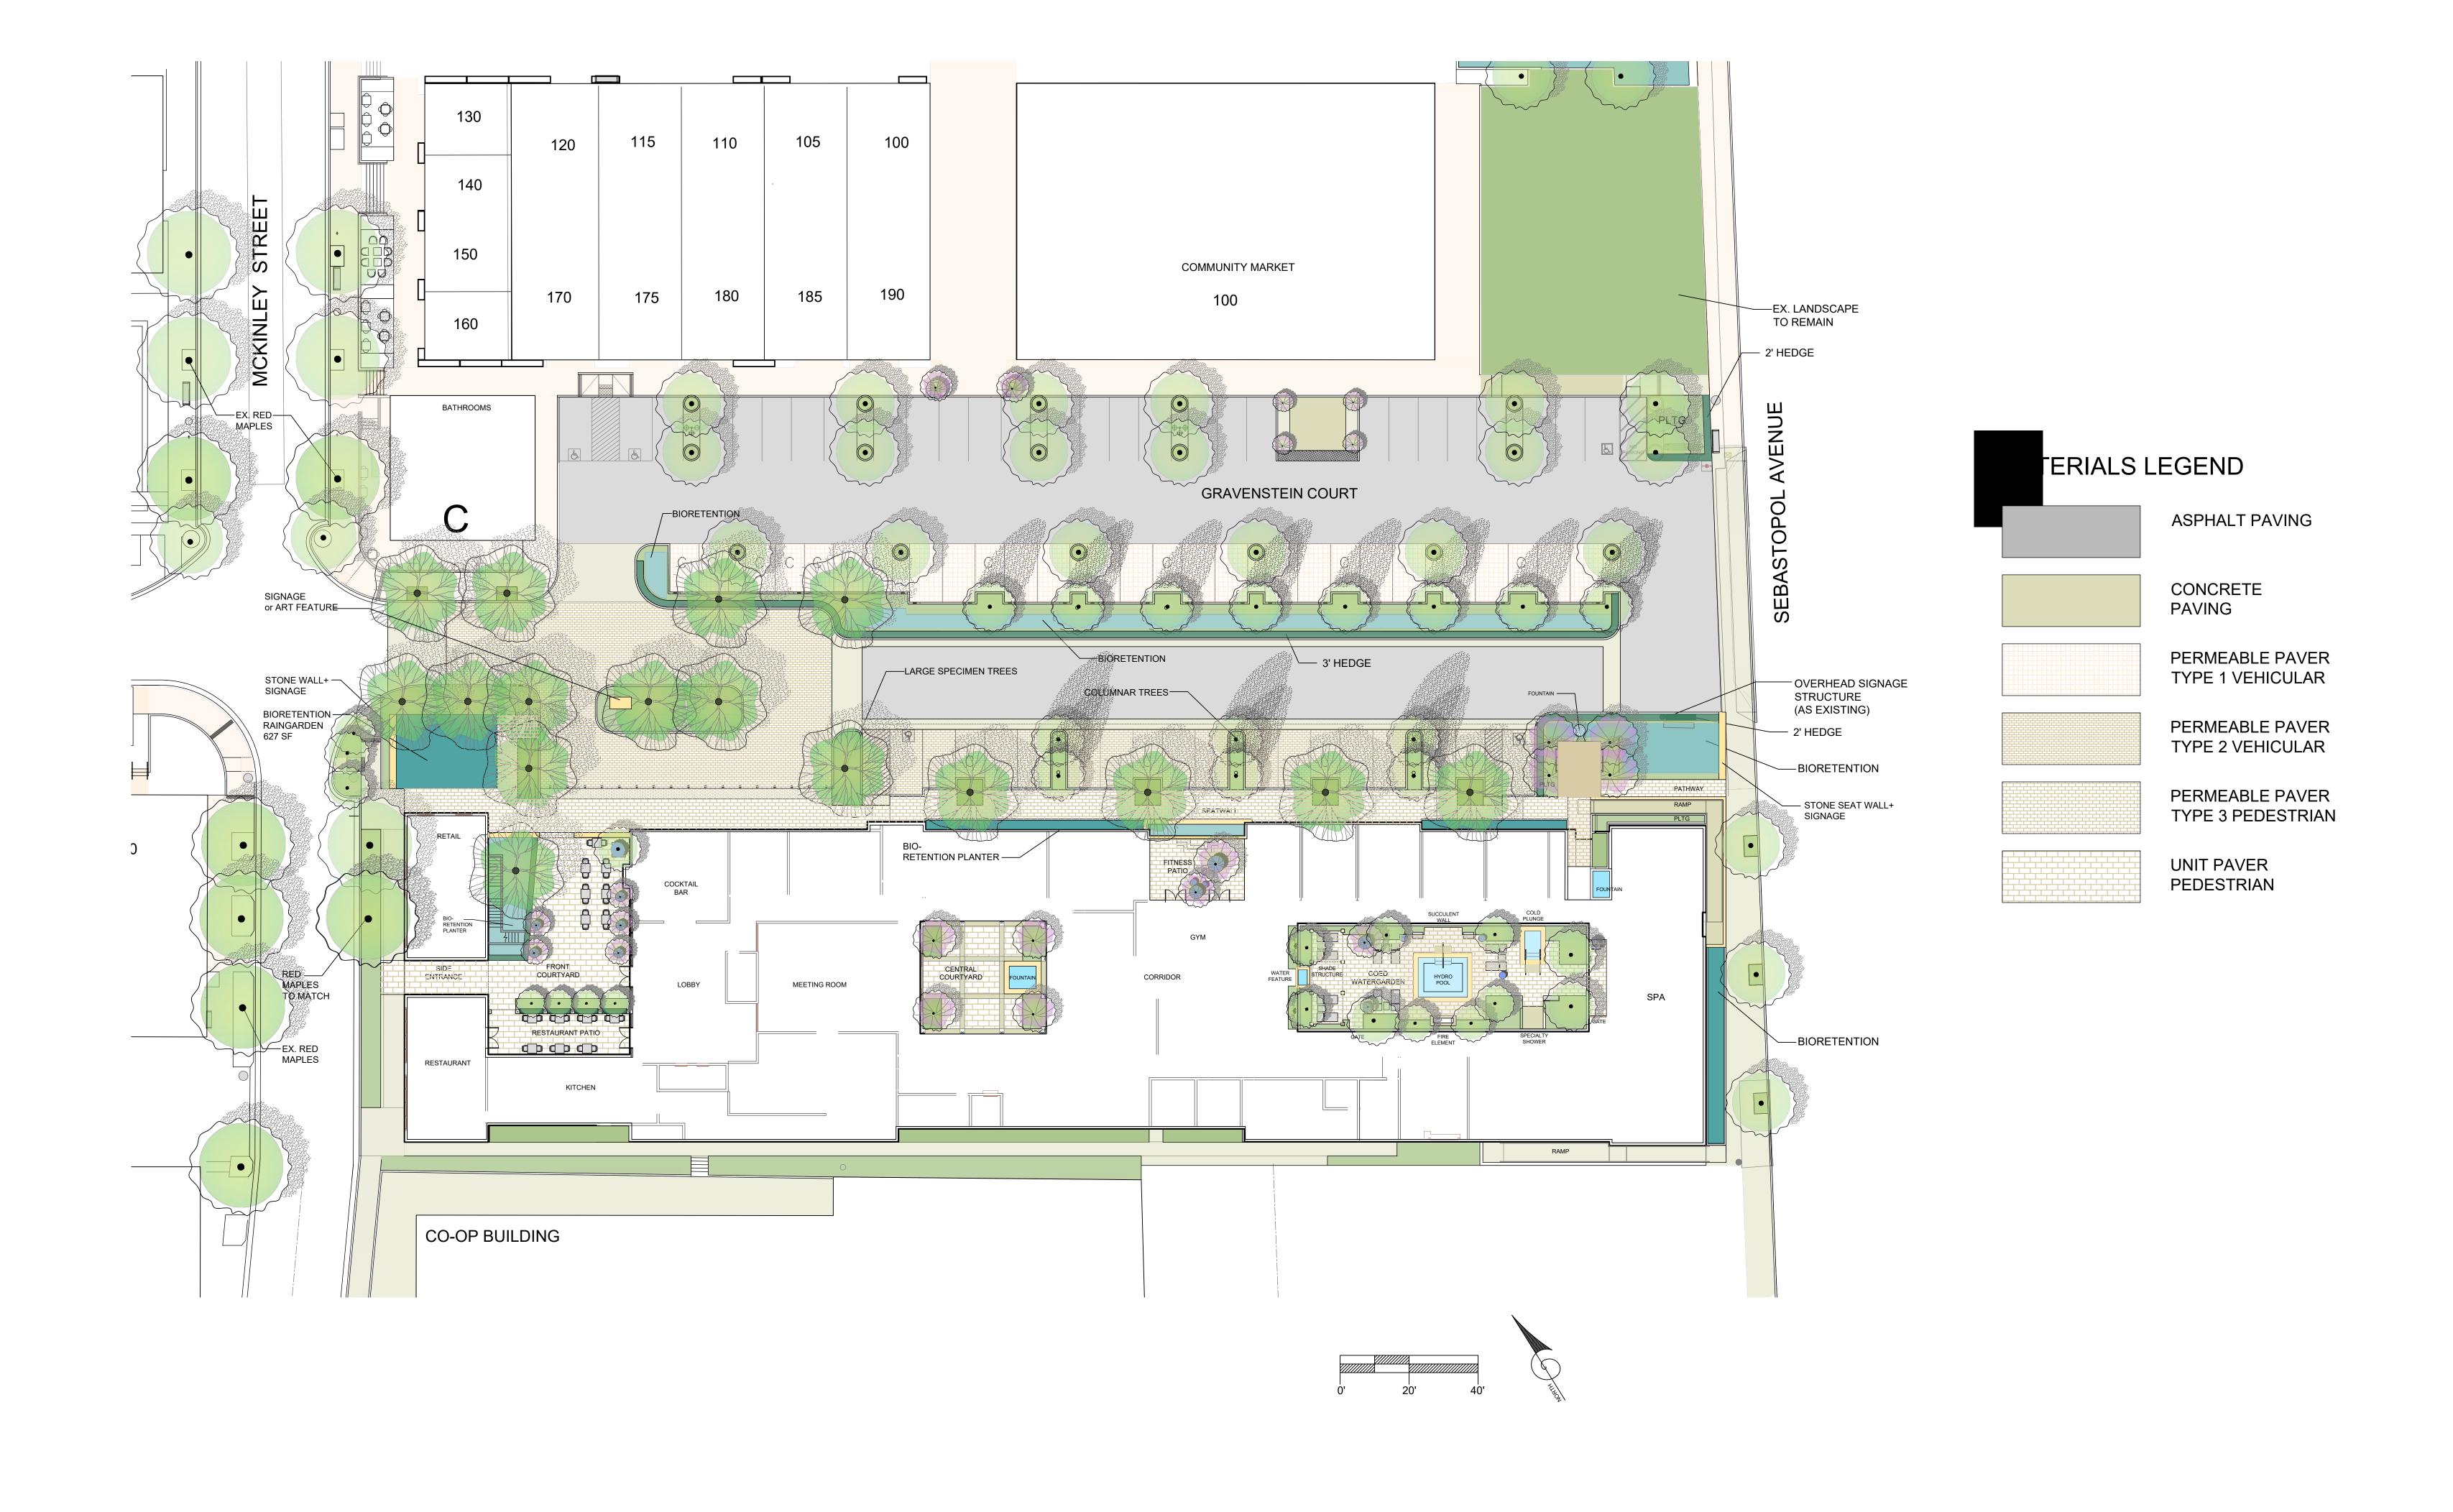


















L1.01

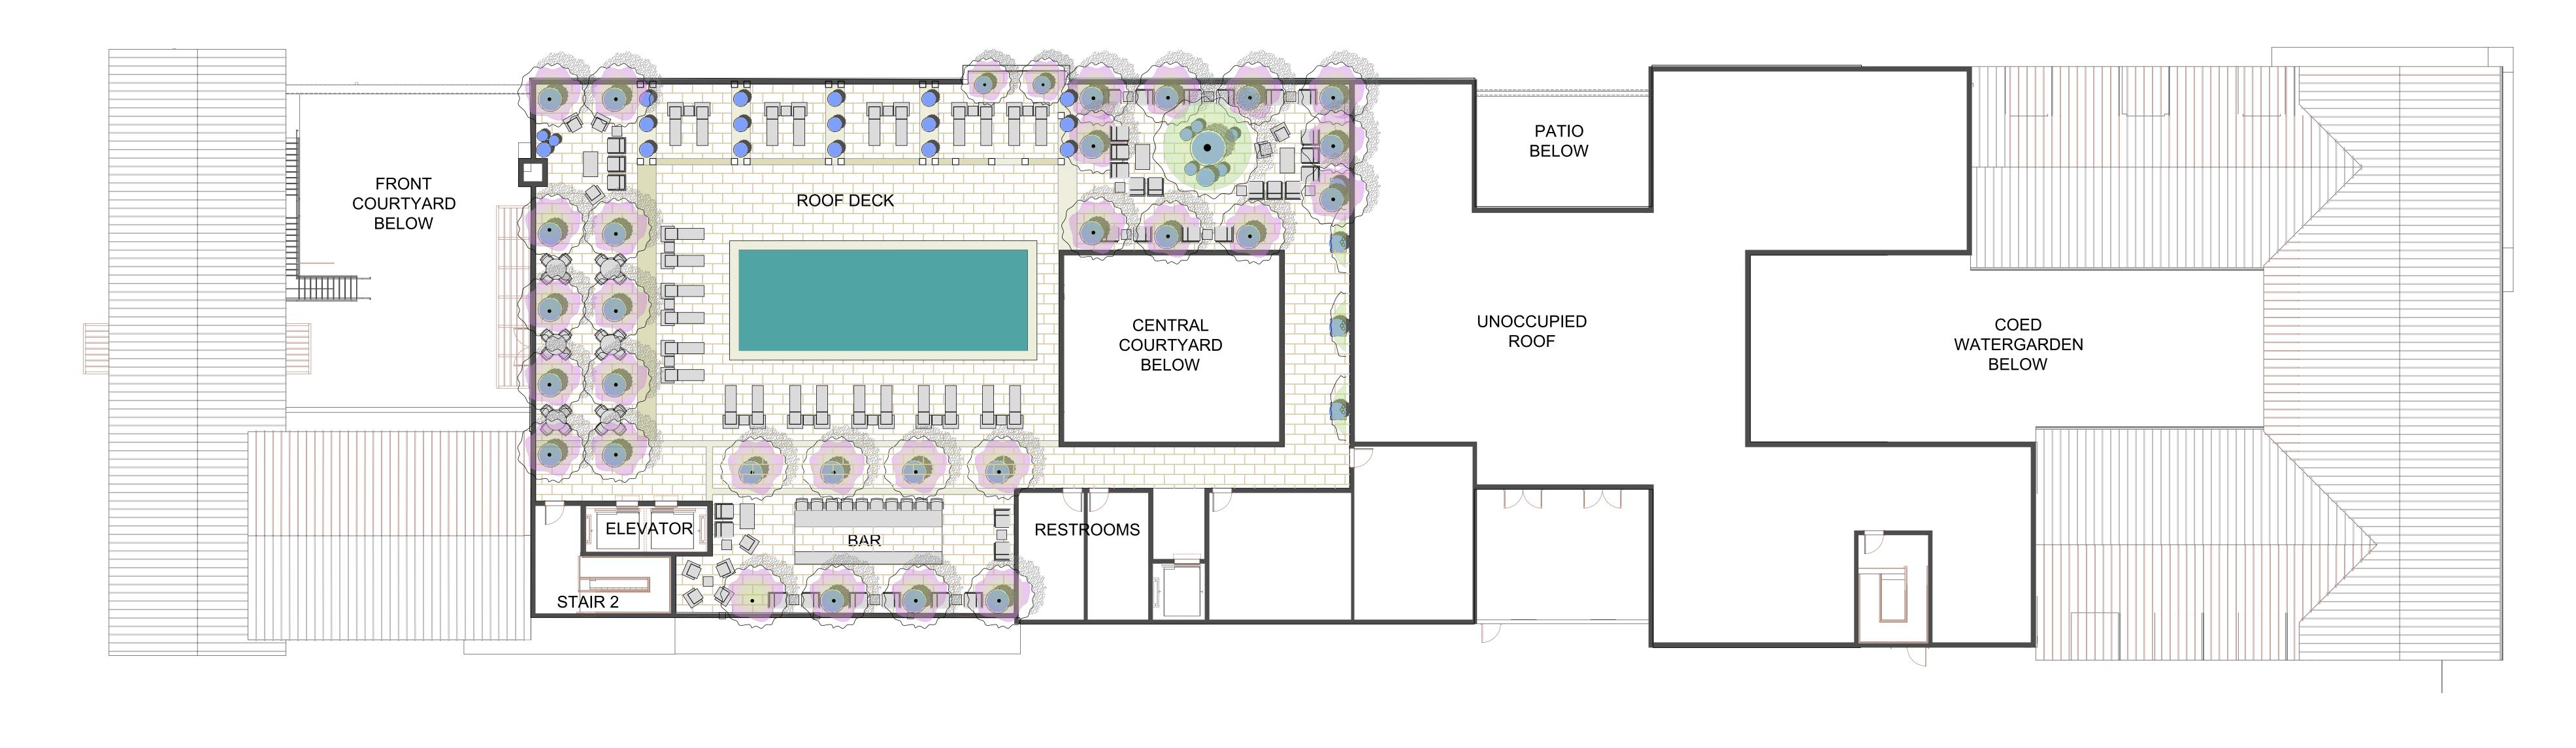



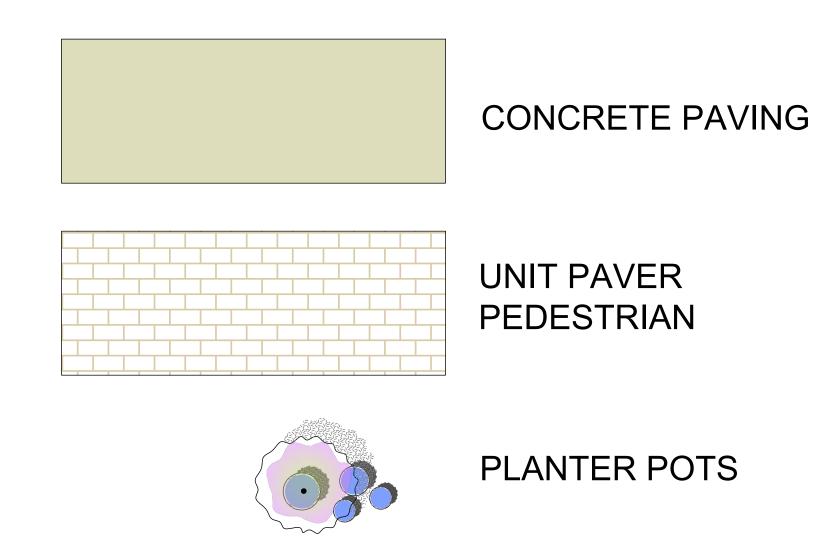

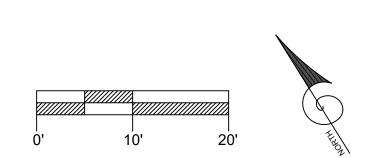









A R C H I T E C T U R E



Landscape Architects, Inc. 405 East D Street Suit H Petaluma, California 94952 (707) 696-2967 sr@zaclandscape.com PLANTING SITE PLAN

L2.0

THE BARLOW HOTEL

### **BIORETENTION PLANTING LEGEND**

CODE	BOTANICAL NAME	COMMON NAME	SIZE	D	E	N	Dr		BI O		GENERAL DESCRIPTION
TREE LEGEND											
ACE CIR	ACER CIRCINATUM	VINE MAPLE	15 GAL	D		Ν		M	В		DE,5-35H ORG/RED FALL CLR SHADE RIPARIAN HIGH & BIORETENTION
ACE DAV	ACER DAVIDII	DAVID'S MAPLE	15 GAL	D		N		М	В	F	DEC 20-35H20-35W SHINY GRN BRK GLOSSY GRN LVS ORG/RED/PURP FALL CLR PT SHADE
AES CAR	AESCULUS CARNEA	RED HORSE CHESTNUT	15 GAL	D			Dr	М	В		DEC 25-40H 20-30W FUSCHIA RED FRGT LRG LVS
CER CAN	CERCIS CANADENSIS	REDBUD	15 GAL				Dr	M	В	F	DEC 20-30H 20-30W PNK
MAG GRA D	MAGNOLIA G. DD BLANCHARD	BLANCHARD MAGNOLIA	15 GAL	D				M	В		EV 20-25H10-15W WHT 5" FLWR DK GRN RUST LVS ESPALIER
MAG GRA L	MAGNOLIA GRANDIFLORA LITTLE GEM	LITTLE GEM MAGNOLIA	15 GAL	D				M	В		EV 20-25H10-15W WHT 5" FLWR DK GRN RUST LVS ESPALIER
QUE AGR	QUERCUS AGRIFOLIA	CALIF. LIVE OAK	15 GAL	D		Ν	Dr	VL	В		EV 50-70H 50-70W RIPARIAN HIGH & BIORENTION
QUE LOB	QUERCUS LOBATA	VALLEY OAK	15 GAL	D		Ν	Dr	L	В		DEC 70H 70W YEL FALL CL RIPARIAN MID-HIGH & BIORETENTION
SAL LAS	SALIX LASIOLEPIS	ARROYO WILLOW	15 GAL			Ν		Н	В		DEC 6-50H NARROW ROUNDED LVS STREAM BANKS THICKETS MF CATKINS RIPARIAN LOW-MID-HIGH & BIORETENTION
SAL LAE	SALIX LAEVIGATA	RED WILLOW	15 GAL			Ν		Н	В		RIPARIAN LOW-MID-HIGH & BIORENTION
CODE	BOTANICAL NAME	COMMON NAME	SIZE	D	E	N	Dr				GENERAL DESCRIPTION
SHRUB & PERENNIAL											
CAL OCC	CALYCANTHUS OCCIDENTALIS	SPICEBUSH	5 GAL	D		Ν	Dr	L	В		DEC 4-12H 4-12W RED/BROWN FRAG brd
CAR CAL	CARPENTERIA CALIFORNICA	BUSH ANEMONE	5 GAL	D		N	Dr	M	В	F	EV 4-6H 4-6W SNGL WHT SPR-SUM PART SHADE
DES CAE M	DESCHAMPSIA CESPITOSA	PACIFIC HAIRGRASS	1 GAL				Dr	L	В		2-3"H 8-12"W GRN TO GOL BRN SUN/PT SHD
ELY GLA	ELYMUS GLAUCUS	BLUE LYME GRASS	2" PLUG			Ν	Dr	L	В		PER GRAY-GRN FOL
ELY TRI	ELYMUS TRICICOIDES	CREEPING WILD RYE	2" PLUG			Ν	Dr	L	В		BIORETENTION HIGH & LOW ZONES
EPI CAN	EPILOBIUM CANUM	CALIFORNIA FUCHSIA	4" POT	D		N	Dr	L	В	F	EV 1-2H1-2W CLUMPING RED PT SHD FIRE TOL BUTT HUM BIRDS FALL FLRS
FES RUB	FESTUCA RUBRA	RED FESCUE	SEED				Dr	L	В		EV SPREADING BY RHIZOMES CAN BE MOWED TO 2" DRK GREEN
HOR BRA	HORDEUM BRACHYANTHERUM	MEADOW BARLEY GRASS	SEED			N	Dr	NR	В		TOL WET CLAY SOILS & GRAVEL
PHI LEW	PHILADELPHUS LEWISII	MOCK ORANGE	5 GAL			Ν	Dr	M	В		DEC PT SHD WHT FRAG
PHI MEX	PHILADELPHUS MEXICANUS	EVERGREEN MOCK ORANGE	5 GAL	D		N	Dr	L	В		EV 6-15H VINING PT SHD WHT FRAG BANK COVER
POL CAL	POLYSTICHUM CALIFORNICUM	CALIF. SWORD FERN	1 GAL	D		Ν		M	В	F	EV 3H3W SHADE GOOD UNDER OAKS CAN TAKE MOIST SOIL EV 2-4H2-4W LEATHERY DRK GRNSHADE GOOD UNDER OAKS
POL MUN	POLYSTICHUM MUNITUM	WESTERN . SWORD FERN	1 GAL	D		Ν		M	В	F	CAN TAKE MOIST SOIL
ROS OFF	ROSMARINUS OFFICINALIS	ROSEMARY	1 GAL	D	E		Dr	L	В	F	EV 1-6H2-6W LAV

#### LARGE TREES LEGEND

CODE LARGE TREE LEGEND	BOTANICAL NAME	COMMON NAME	SIZE DEN	l Dr	¥ -	3	GENERAL DESCRIPTION
ACE FRE A	ACER FREEMANII 'ARMSTRONG'	RED MAPLE ARMSTRONG	24" BOX D		M		F DEC 40H 15W POOR OR-RD FALL CLR
ACE RUB O	ACER RUBRUM 'OCTOBER GLORY'	RED MAPLE OCTOBER GLORY	24" BOX D		M	В	F DEC 60H 40W RED FALL CLR
ACE RUB C	ACER RUBRUM 'COLUMNARE'	RED MAPLE COLUMNAR	24" BOX D		M		F DEC 30H 10W ORG/RD FALL CLR
MAG GRA D	MAGNOLIA G. DD BLANCHARD	BLANCHARD MAGNOLIA	24" BOX D		M	В	EV 20-25H10-15W WHT 5" FLWR DK GRN RUST LVS ESPALIER
MAG GRA L	MAGNOLIA GRANDIFLORA COLUMNARE LITTLE GEN	M LITTLE GEM MAGNOLIA	24" BOX D		M	В	EV 20-25H10-15W WHT 5" FLWR DK GRN RUST LVS ESPALIER
OLEA EUR N	OLEA EUROPA NON FRUITING	NON-FRUITING OLIVE	36" BOX D	Dr	٧L	•	F EV25H25W GREY FOL
PLA ACE B	PLATANUS ACERIFOLIA 'BLOODGOOD'	SYCAMORE	36" BOX		M		F DEC 60H 30W FAST
ULM PAR A	ULMUS PARVIFOLIA 'ALLEE'	EVERGREEN ELM	36" BOX	Dr	L		F SEMI EV 70H 60W VASE SHP

#### **GENERAL PLANTING LEGEND**

CODE ACCENT TREE	BOTANICAL NAME	COMMON NAME	SIZE	D	E I	N	Dr	, N		GENERAL DESCRIPTION
LEGEND										
AZA GEI ESP	AZALEA GEISHA ESPALIER	GEISHA AZALEA	15 GAL					М	F	TALL SPREAD WHT/CHART
COR EDD	CORNUS 'EDDIES WHITE WONDER'	WHITE DOGWOOD	24" BOX							DEC 20-30H 20-30W, WHT
LAG NAT	LAGERSTROEMIA 'NATCHEZ'	WHITE CRAPE MYRTLE	24" BOX	D		1	Dr	L	F	DEC 25H12W WHT ORG-RED FALL
PIT TEN M	PITTOSPORUM TENUIFOLIUM 'MARJORIE CHANNON'	MARJORIE CHANNON	15 GAL			1	Dr	M	F	EV 8H 8W LVS PALE GREEN VARIAG
PIT TOB V	PITTOSPORUM TOBIRA VARIAGATA	VARIGATED PITTOSPORUM	15 GAL	D		1	Dr	L	F	EV 6-15H 6-15W FRAG VAR LVS
POD GRA	PODOCARPUS GRACILIOR	FERN PINE	15 GAL	D				М		EV 20H10-20W COLMNR DRK GRN ESPALIER
VIB PLI M	VIBURNUM PLICATUM TOMENTOSUM 'MARIESII'	VIBURNUM	15 GAL	D				М		DEC 6H 3-4W WHT
CODE SHRUB & VINE LEGEND	BOTANICAL NAME	COMMON NAME	SIZE	DI	E I	N I	Dr i	CO CO		GENERAL DESCRIPTION
BUX MIC W	BUXUS MICROPHYLLA JAPONICA WINTER GEM	WINTER GEM BOXWOOD	I GAL					М		EV 2-6H 2W
CAL OCC	CALYCANTHUS OCCIDENTALIS	SPICEBUSH  JAPANESE CAMELLIA-EALRY	5 GAL	D	1	N I	Dr	L		DEC 4-12H 4-12W RED/BROWN FRAG brd
CAM JAP A	CAMELLIA JAPONICA ALBA PLENA	SEASON JAPANESE CAMELLIA-LATE	5 GAL						F	EV 6-12H 6-12W LRG WHT DBL P SHADE
CAM JAP P	CAMELLIA JAPONICA PURITY	SEASON	5 GAL						F	EV 6-12H6-12W WHT P SHADE
CAR CAL	CARPENTERIA CALIFORNICA	BUSH ANEMONE	5 GAL	D	1	N I	Dr	М	F	EV 4-6H 4-6W SNGL WHT SPR-SUM PART SHADE
CHO TER	CHOISYA TERNATA	MEXICAN ORANGE	5 GAL	D		1	Dr	M		EV 6-8H 6-8W WHT FRAG
CLE SPE	CLEMATIS SPECIES	CLEMATIS	5 GAL							EV & DEC VINES 6-20' ALL TIMES
COR COR C	CORYLUS CORNUTA CALIFORNICA	WESTERN HAZELNUT	5 GAL		1	Ν		L	F	DEC 5-12H 5-12W YEL WITHSTANDS DAMP SOIL EDIBLE NUTS
HYD PAN L	HYDRANGEA PANICULATA 'LIMELIGHT'	HYDRANGEA LIMELIGHT	5 GAL	D				М	F	DEC 6-10H10W WHT CONE SFLWR P SHADE
HYD QUE S	HYDRANGEA QUERCIFOLIA 'SNOW QUEEN'	OAKLEAF HYDRANGEA-QUEEN	5 GAL	D				М	F	DEC 5H WHT LRG LVS RED FALL BUT
JAS OFF	JASMINUM OFFICINALE	COMMON JASMINE	1 GAL					L	F	EV 12H VINE WHT FRAG
LOR CHI A	LOROPETALUM CHINENSE 'ALBUS'	WHITE LOROPETALUM	5 GAL					М		EV 6H6W FLW WHT SHADE
PAR TRI	PARTHENOCISSUS TRICUSPIDATA	BOSTON IVY	5 GAL					L		DEC 50H VINE ORG-RED FC
PEN EAT	PENSTEMON EATONII	EATONS PENSTEMON	5 GAL	D		N I	DR	L		EV 2H1.5W RE ATTRACTS BUT & HUM
PHI MEX	PHILADELPHUS MEXICANUS	EVERGREEN MOCK ORANGE	5 GAL		1	N I	Dr	L		EV 6-15H VINING PT SHD WHT FRAG BANK COVER
PIT TEN M	PITTOSPORUM TENUIFOLIUM 'MARJORIE CHANNON'	MARJORIE CHANNON	15 GAL			1	Dr	M	F	EV 8H 8W LVS PALE GREEN VARIAG
PIT TOB C	PITTOSPORUM TOBIRA 'CREAM DE MINT'	TOBIRA MINT DWARF	5 GAL			1	Dr	L	F	EV 2H2W VARIAGATED MINT WITH CREAMMY WHT FRAG
PIT TOB W	PITTOSPORUM TOBIRA WHEELERS DWARF	WHEELERS MOCK MORANGE	5 GAL			1	Dr	L	F	EV 2-3H4-5W FRAG
ROM COU	ROMNEYA COULTERI	MATILIJA POPPY	5 GAL	D		N	Dr	<b>V</b> L	F	8H 4W WHT FRA



**L2.1** 








THE BARLOW HOTEL

DECEMBER 20, 2024

## LARGE TREES

### **BIORETENTION PLANTING**

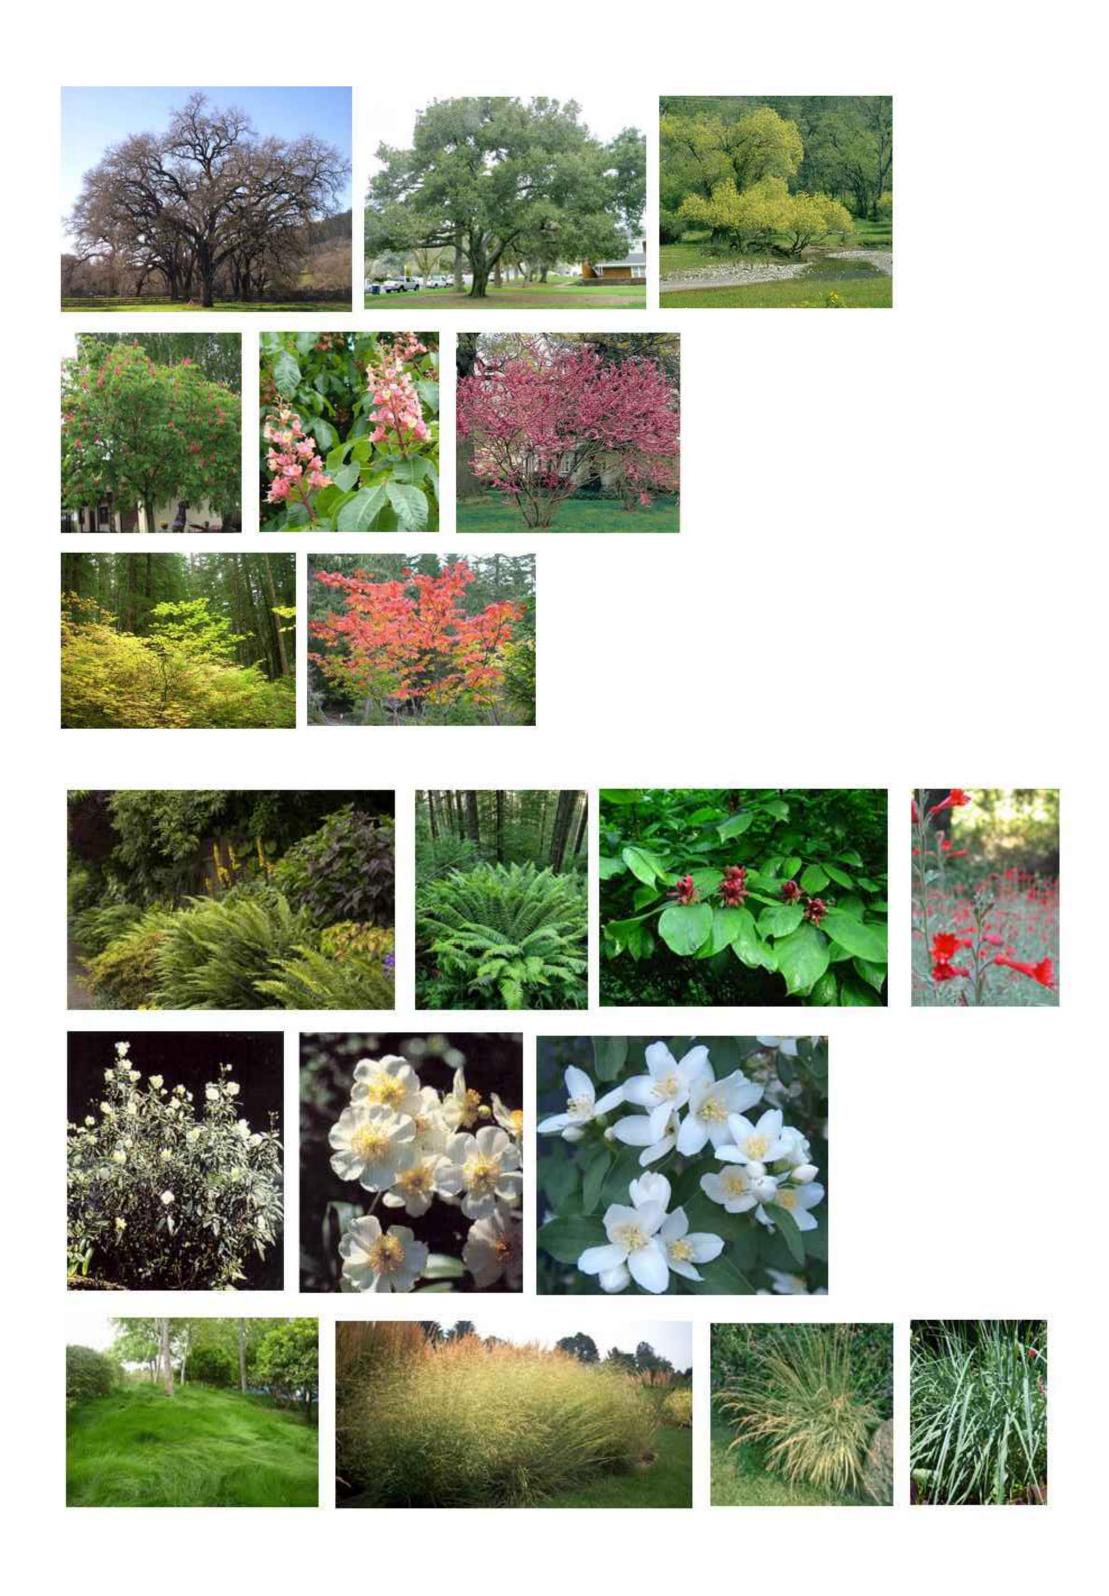





**GENERAL PLANTING** 






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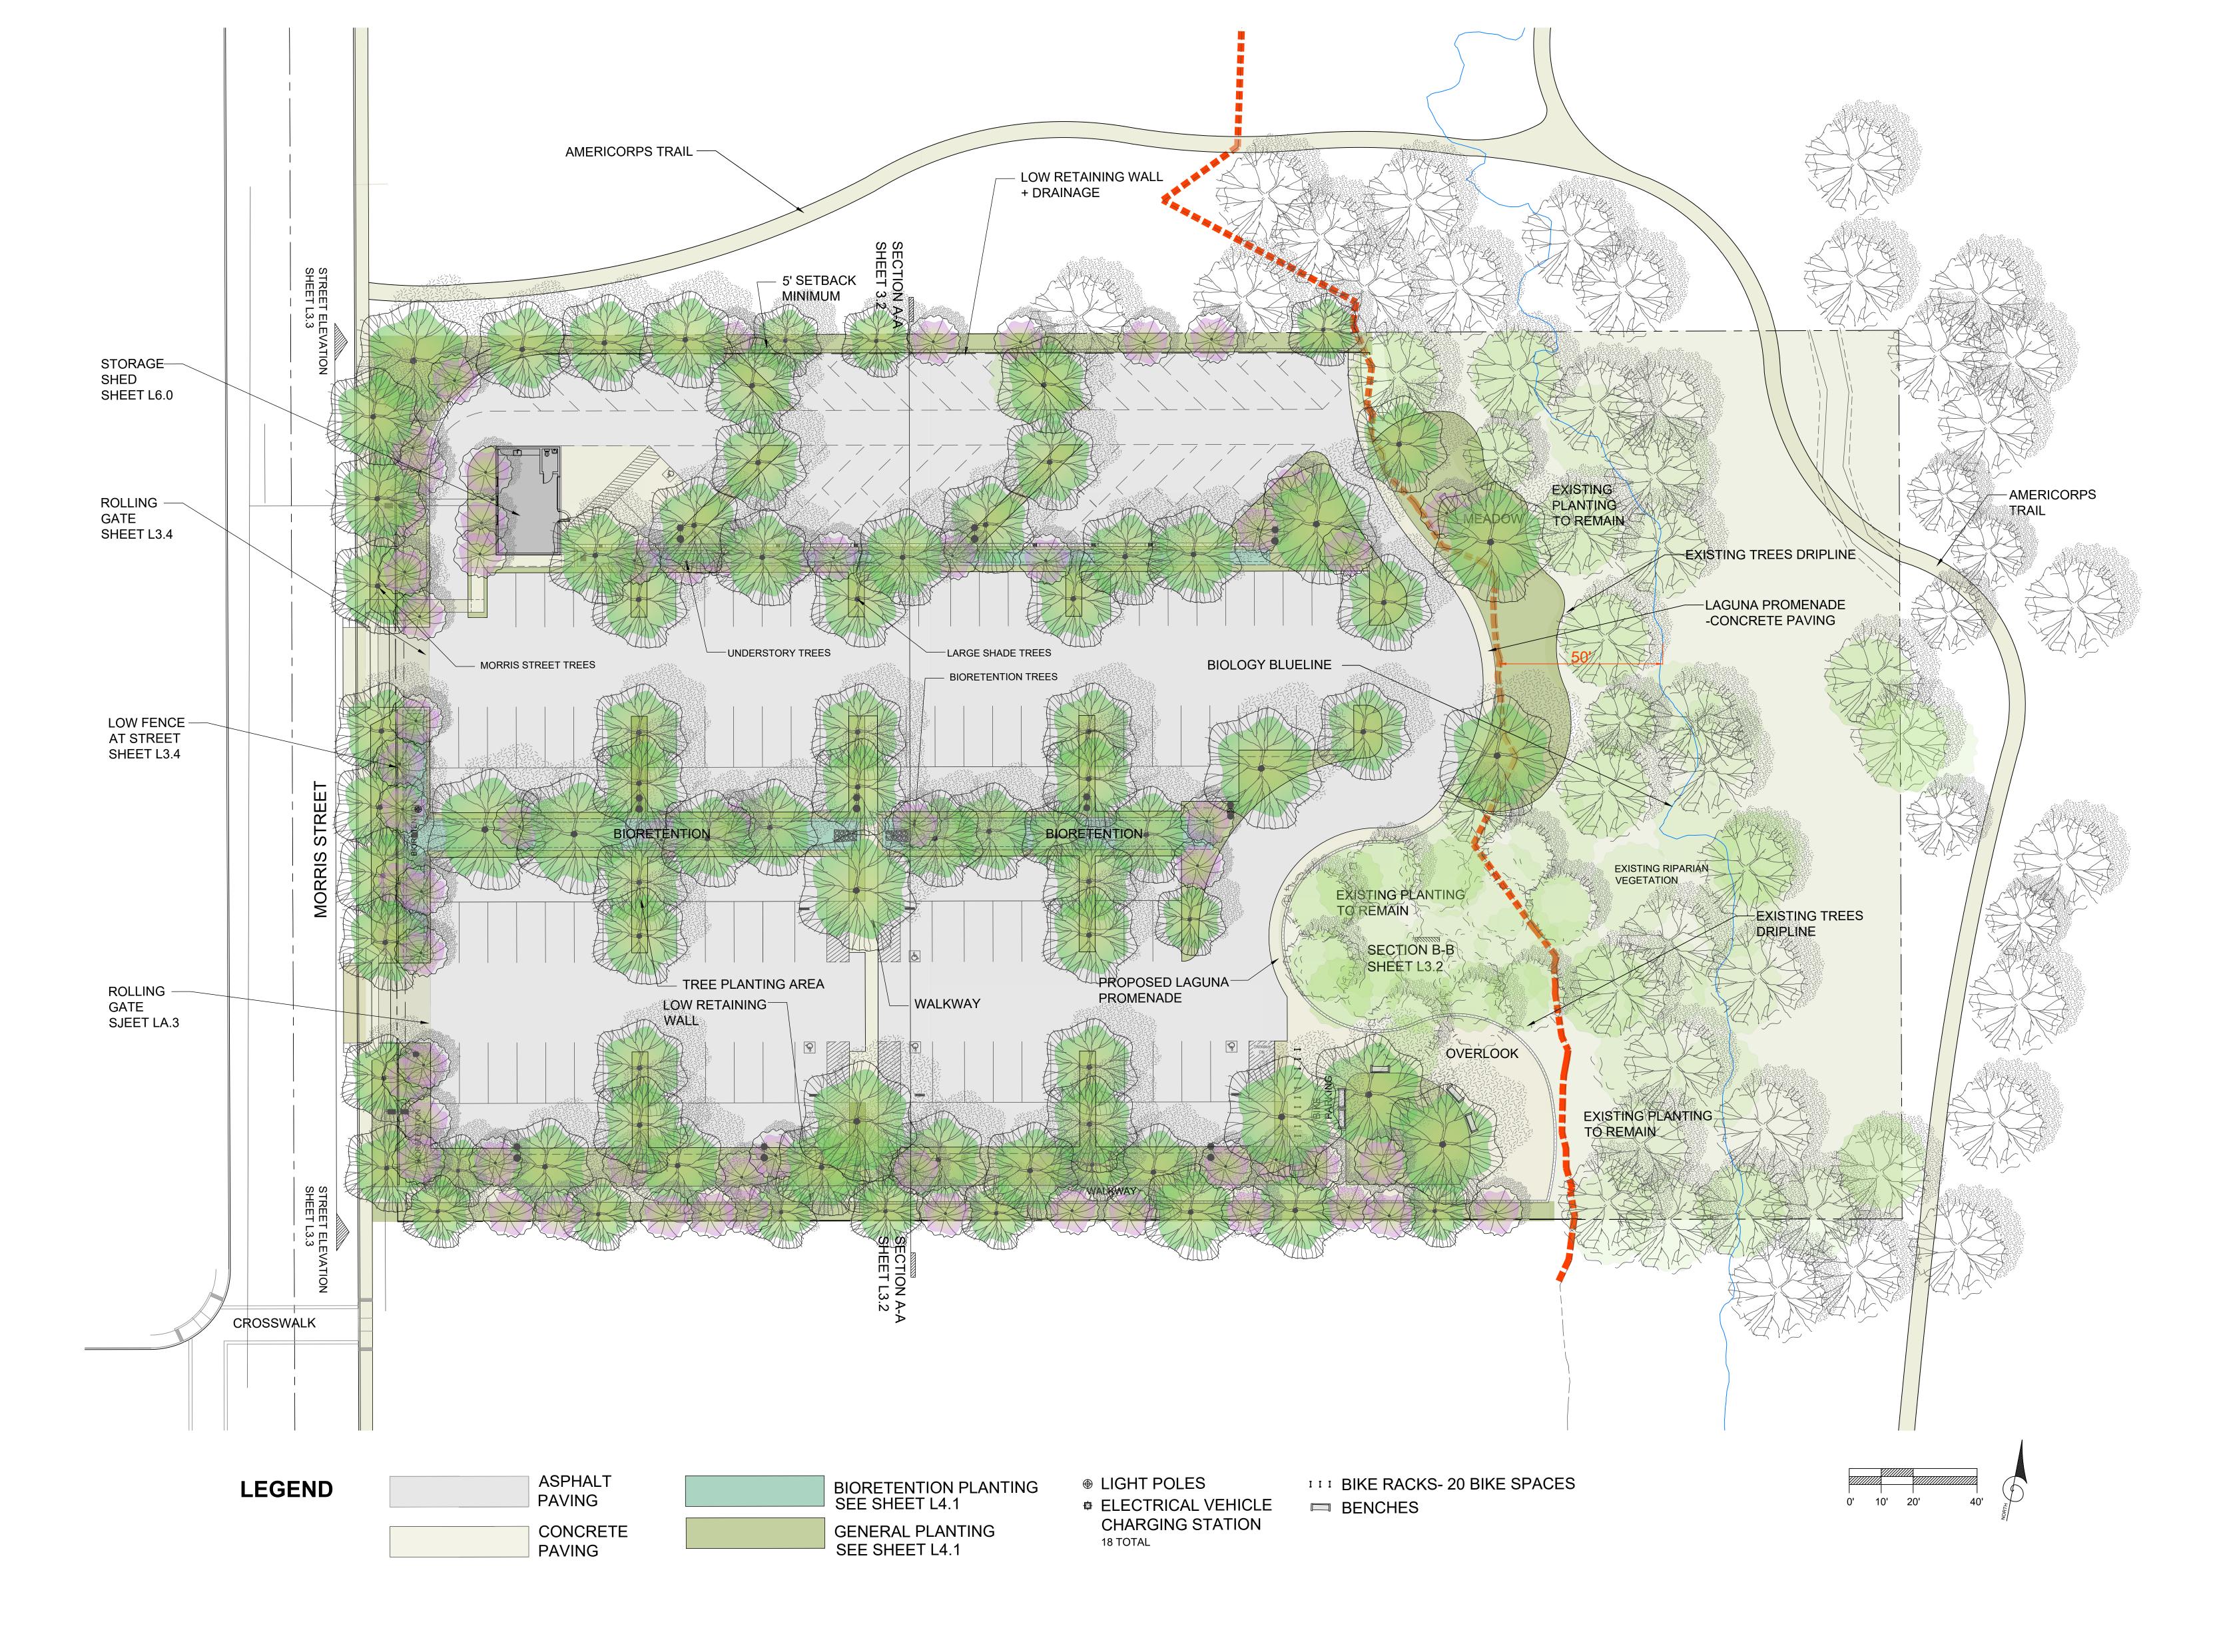








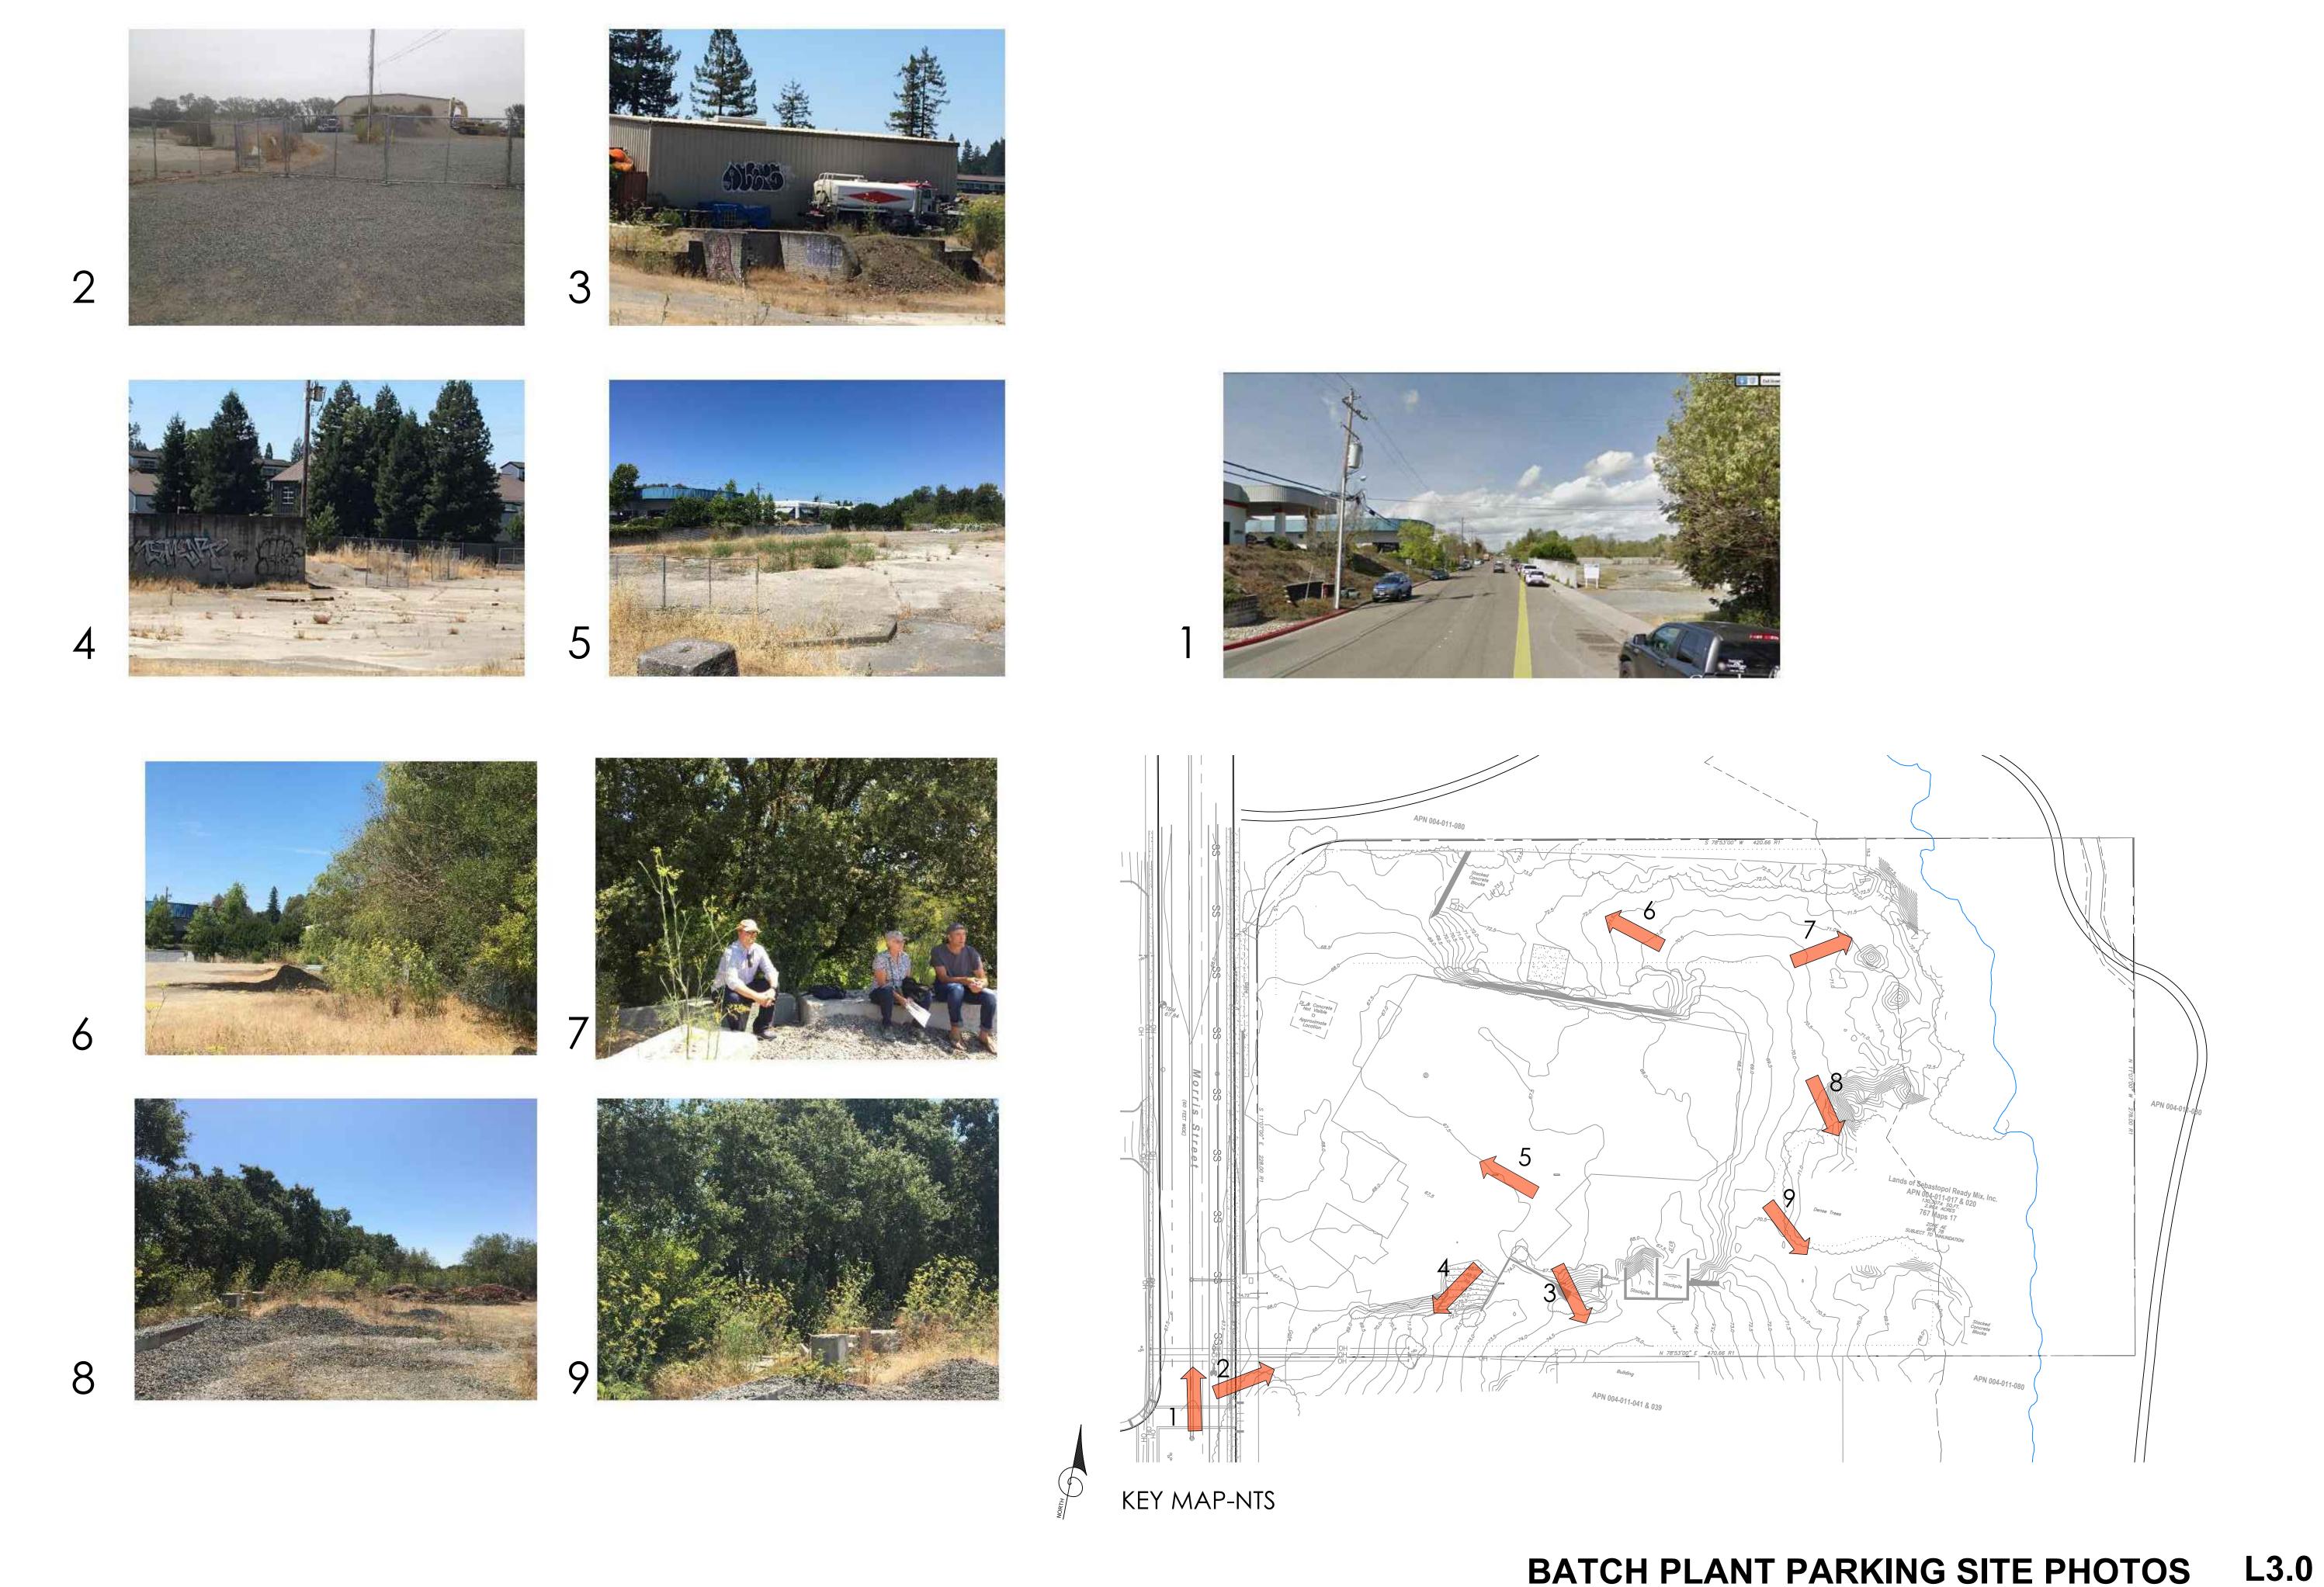













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THE BARLOW HOTEL

DECEMBER 20, 2024

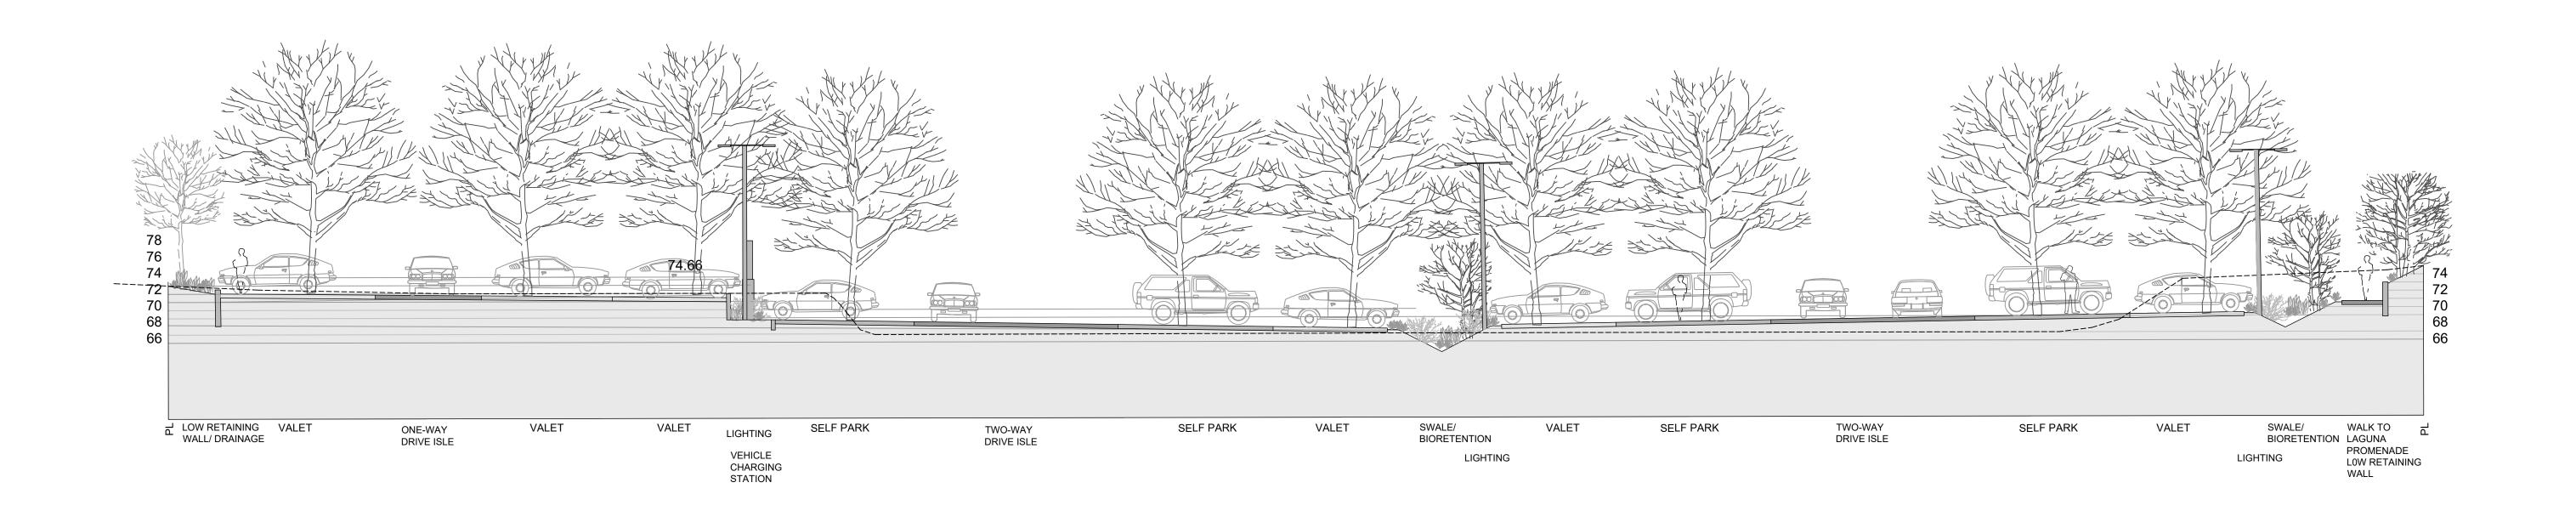


LANDSCAPE SECTION A-A



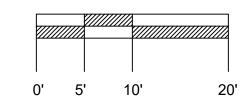






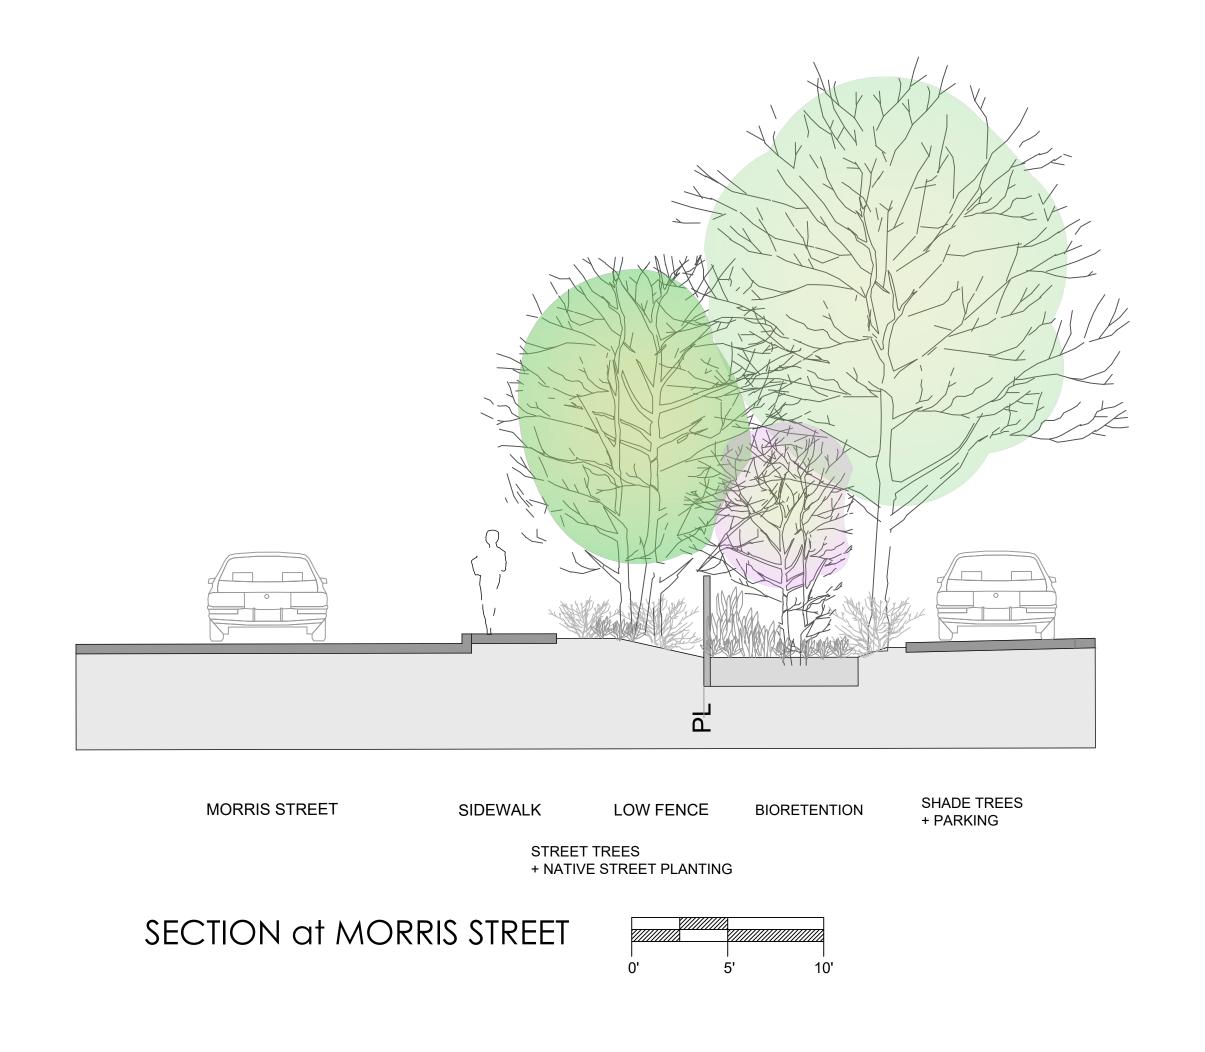




EXISTING CONDITIONS at MORRIS STREET

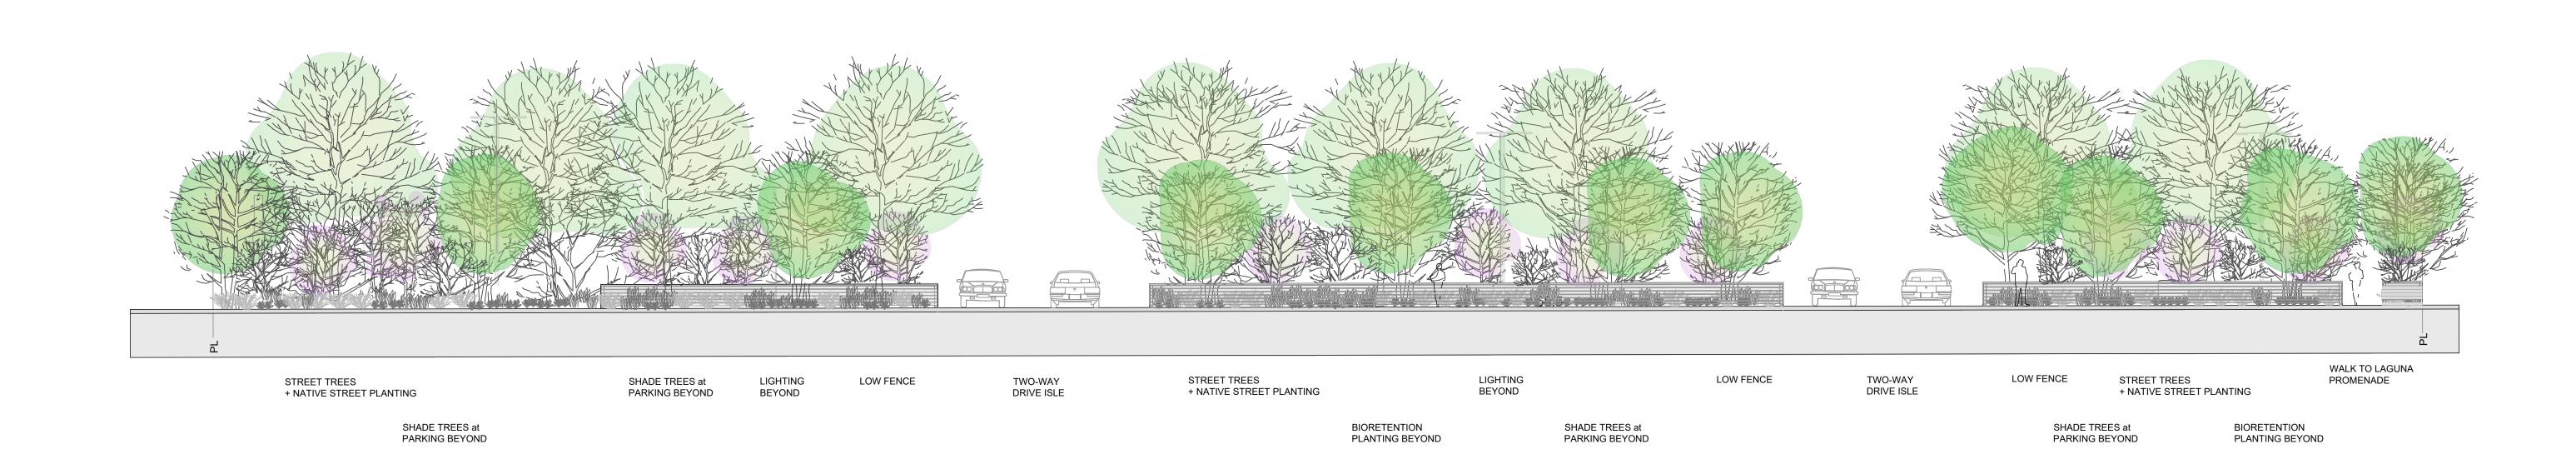

MORRIS STREET ELEVATION

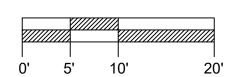











BIKE RACK BY SPORT WORKS INVERTED U MODEL



BENCH
BY LANDSCAPES FORMS
VILLAGE GREEN MODEL



LOW WOOD FENCING AT STREET SLIDING GATES SIMILAR




ARCHITECTURE







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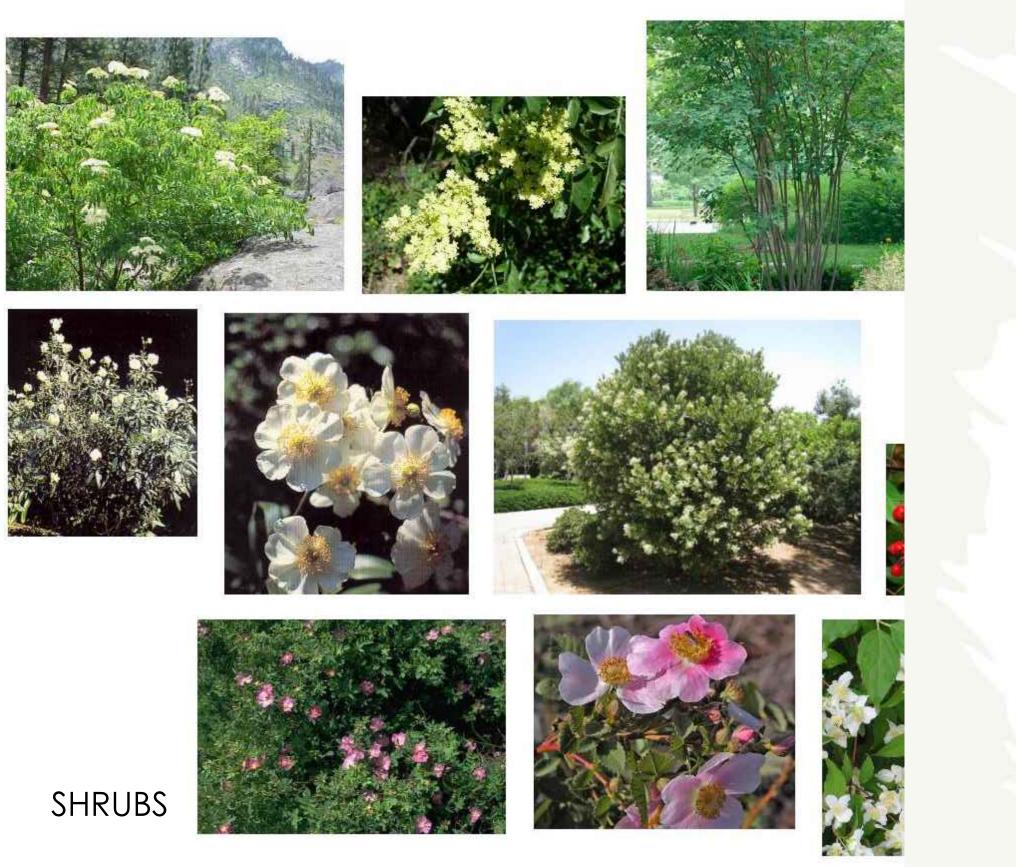


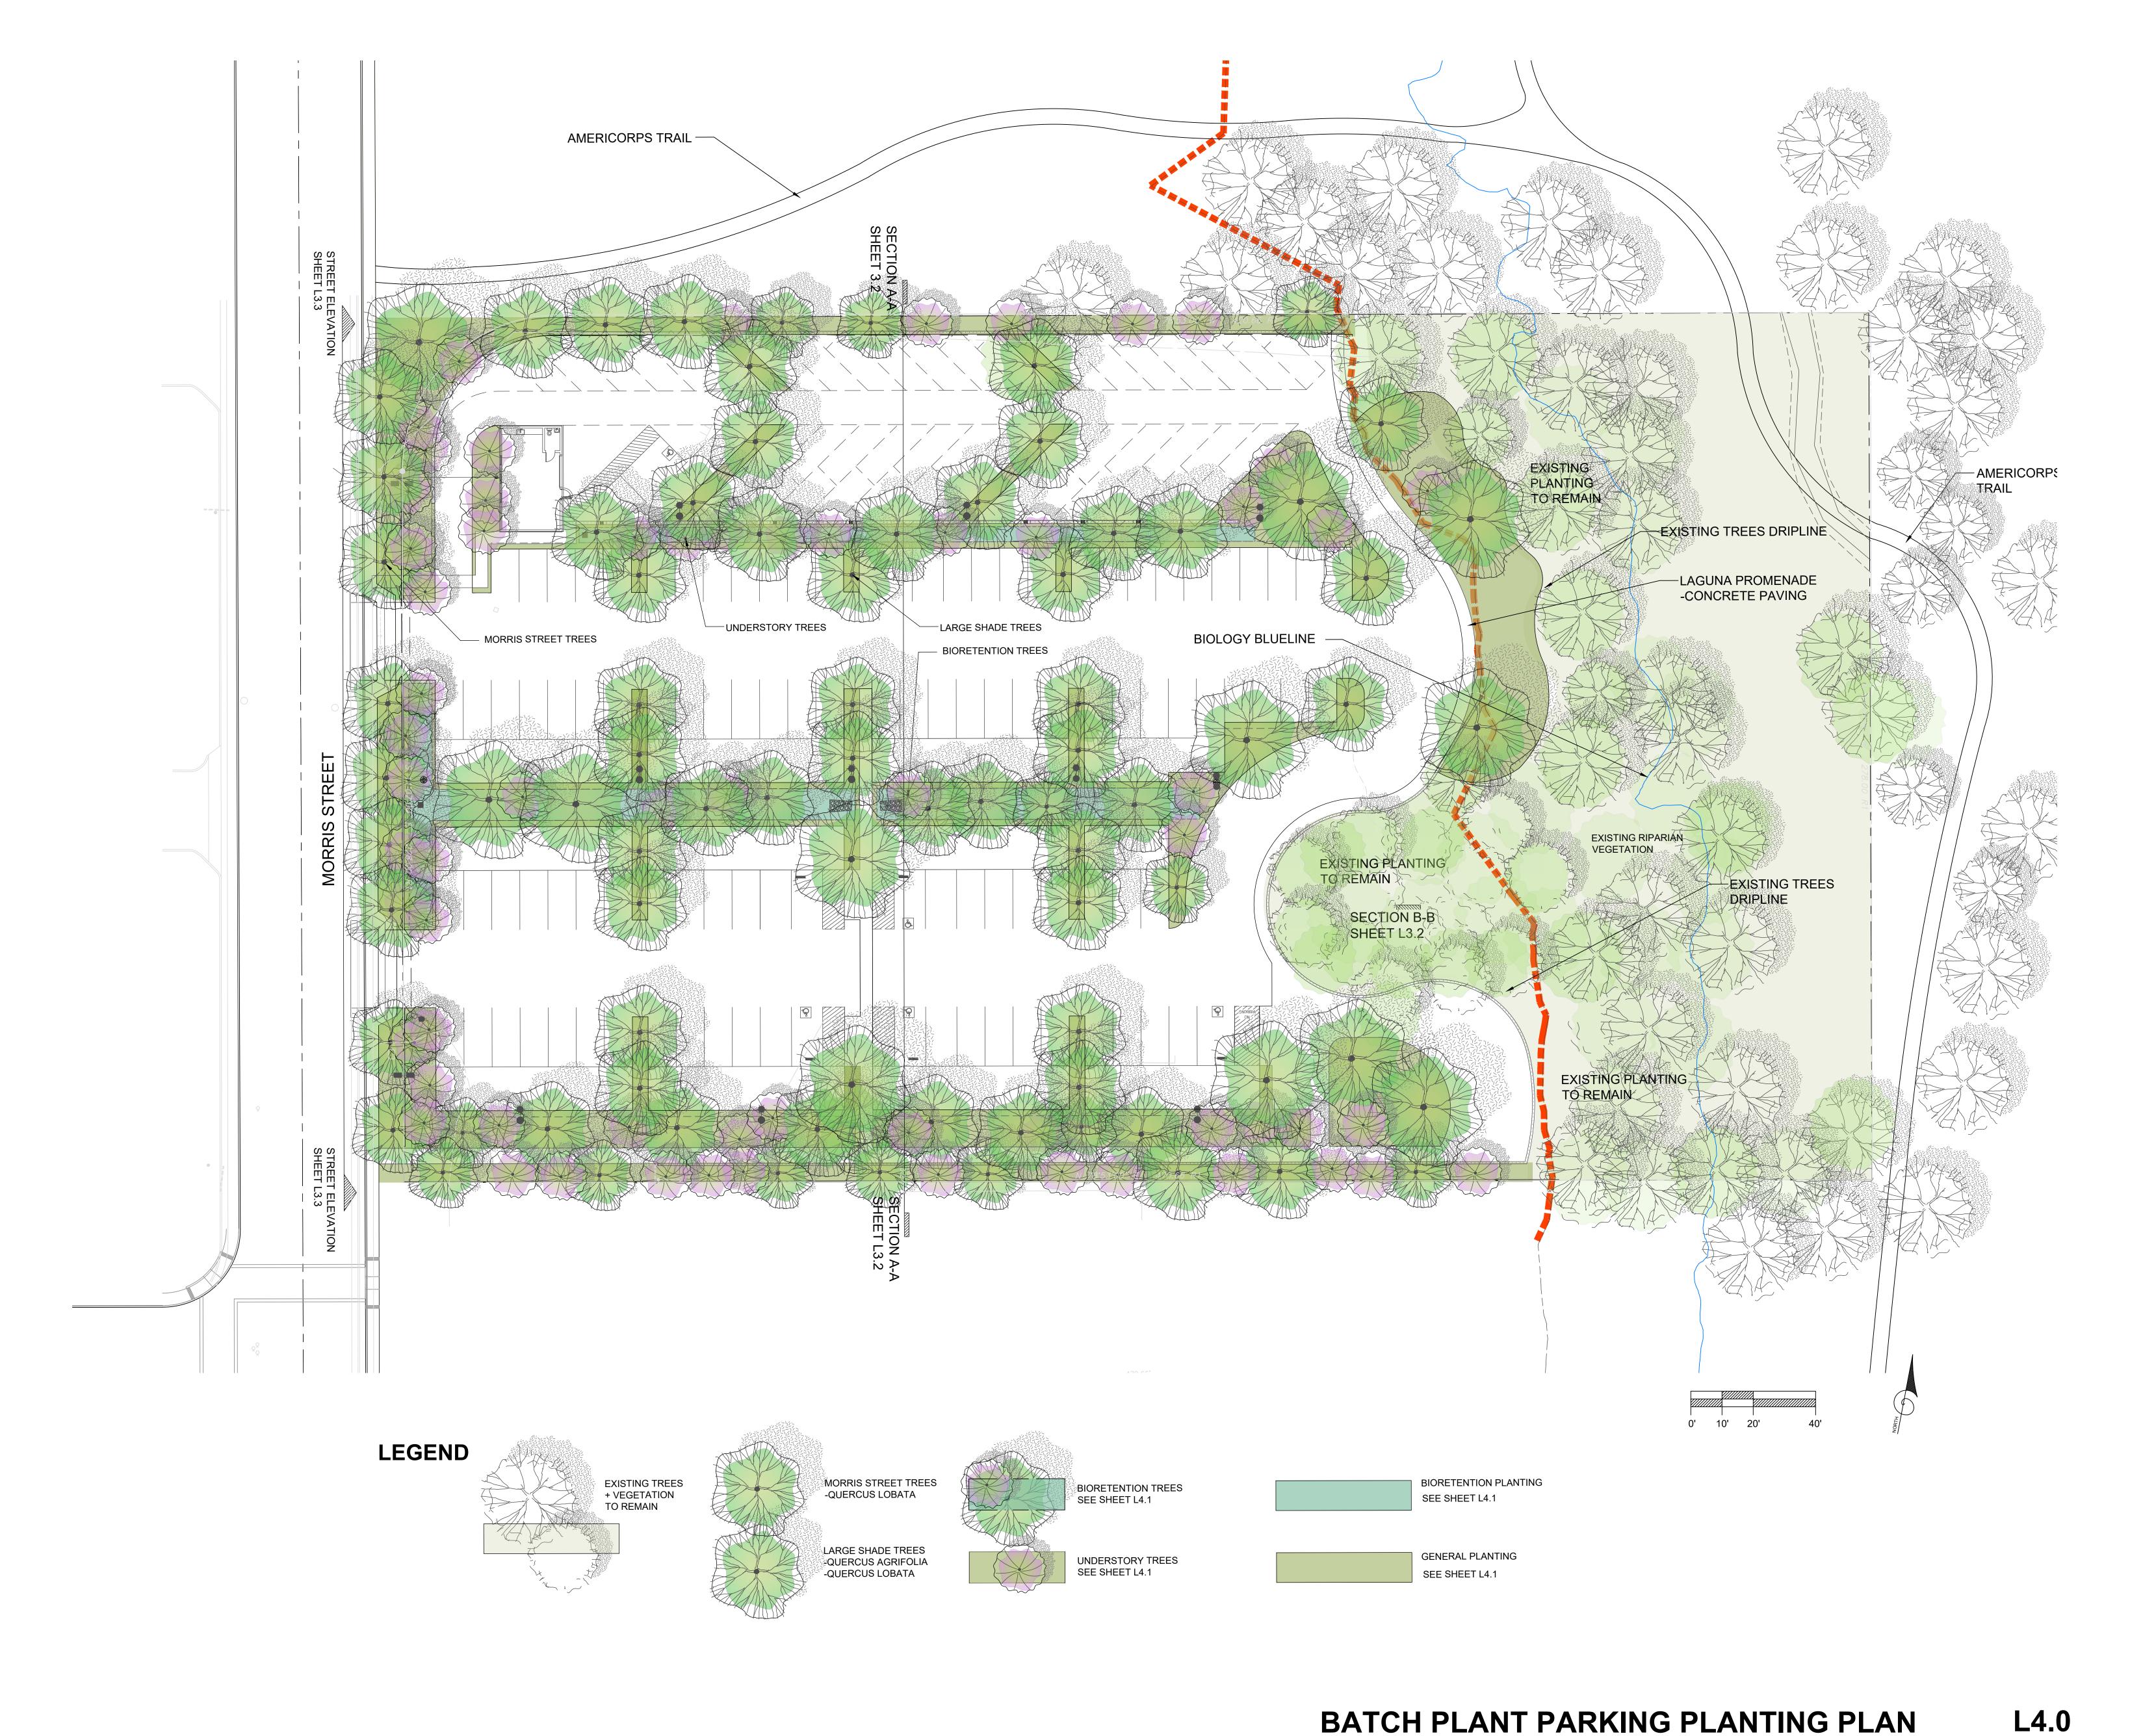



# PLANT LIST

CODE	BOTANICAL NAME	COMMON NAME	SIZE	D	E	N	Dr			GENERAL DESCRIPTION
TREE LEGEND										
ACE CIR	ACER CIRCINATUM	VINE MAPLE	15 GAL	D		N		М		DE,5-35H ORG/RED FALL CLR SHADE RIPARIAN HIGH & BIORETENTION
ACE MAC	ACER MACROPHYLLUM	BIG LEAF MAPLE	15 GAL			Ν				DEC 50-80H 25-60W YL FALL CLR RIPARIAN
AES CAL	AESCULUS CALIFORNICA	CALIFORNIA BUCKEYE	15 GAL	D		N	Dr	VL		DEC 15-45H 20-50W WHT FRGT RIPARIAN HIGH & BIORETENTION
QUE AGR	QUERCUS AGRIFOLIA	CALIF. LIVE OAK	15 GAL	D		Ν	Dr	VL		EV 50-70H 50-70W RIPARIAN HIGH & BIORENTION
QUE LOB	QUERCUS LOBATA	VALLEY OAK	15 GAL	D		N	Dr	L		DEC 70H 70W YEL FALL CL RIPARIAN MID-HIGH & BIORETENTION
SAL LAS	SALIX LASIOLEPIS	ARROYO WILLOW	15 GAL			N				DEC 6-50H NARROW ROUNDED LVS STREAM BANKS THICKETS MF CATKINS RIPARIAN LOW-MID-HIGH & BIORETENTION
SAL LAE	SALIX LAEVIGATA	RED WILLOW	15 GAL			Ν		Н		RIPARIAN LOW-MID-HIGH & BIORENTION
CODE	BOTANICAL NAME	COMMON NAME	SIZE	D	E	N	Dr			GENERAL DESCRIPTION
SHRUB & PERENNIAL										
AME ALN	AMELANCHIER ALNIFOLIA	WESTERN SERVICEBERRY	5 GAL		E	N		L		DEC 10H10W TO THICKETS LIGHT GREEN WHT FLRS RED-YLW FALL EDIBLE BLUEBERRIES MECDICINAL BARK WOOD USED FOR ARROWS TOOLS SHELTERS PROPGATE BY SEEDS HEGE-WINDBREAK
ELYTRI	ELYMUS TRICICOIDES	CREEPING WILD RYE				Ν	Dr	L		BIORETENTION HIGH & LOW ZONES
HET ARB	HETEROMELES ARBUTIFOLIA	TOYON	5 GAL	D		Ν	Dr	L E	3 B	EV 6-18H 5-15W WHT PT SHD RED FRT BRD RIPARIAN
HOL DIS	HOLODISCUS DISCOLOR	CREAM BUSH	5 GAL	D			Dr	L		DEC 3-8H4-8W WHT 1'LONG CLUSTER BIRDS
JUN PAT	JUNCUS PATENS	WIRE GRASS	1 GAL	D		Ν	Dr	L		1-2H1-2W BLUISH LVS WET AREA TOL DROUGHT
PHI LEW	PHILADELPHUS LEWISII	MOCK ORANGE	5 GAL			Ν	Dr	М		DEC PT SHD WHT FRAG
RHA CAL	RHAMNUS CALIFORNICA	COFFEEBERRY	5 GAL			N		L		EV 5-8H 8-10W SUN-SHD RED BLU FRT BUT BRD
RIB AUR	RIBES AUREUM	GOLDEN CURRANT	5 GAL	D		Ν	DR	Ì	-	DEC 3-6H3-6W YEL FRAGRANT LIGHT GRN LVS FRUIT YEL-RED-BLK
ROS CAL	ROSA CALIFORNICA	CALIFORNIA ROSE	1 GAL			N	Dr	L		DEC 3-5H3-8W PIN RED FRT BRD
SAM MEX	SAMBUCUS CAERULEA N. MEXICANA	BLUE ELDERBERRY	5 GAL		E	N	Dr	L		DEC 10-25H8-20W LT GRN CRM WHT BLU/BLK FRUIT EDIBL ALONG STREAMS PRUNE TO KEEP COMPACT
















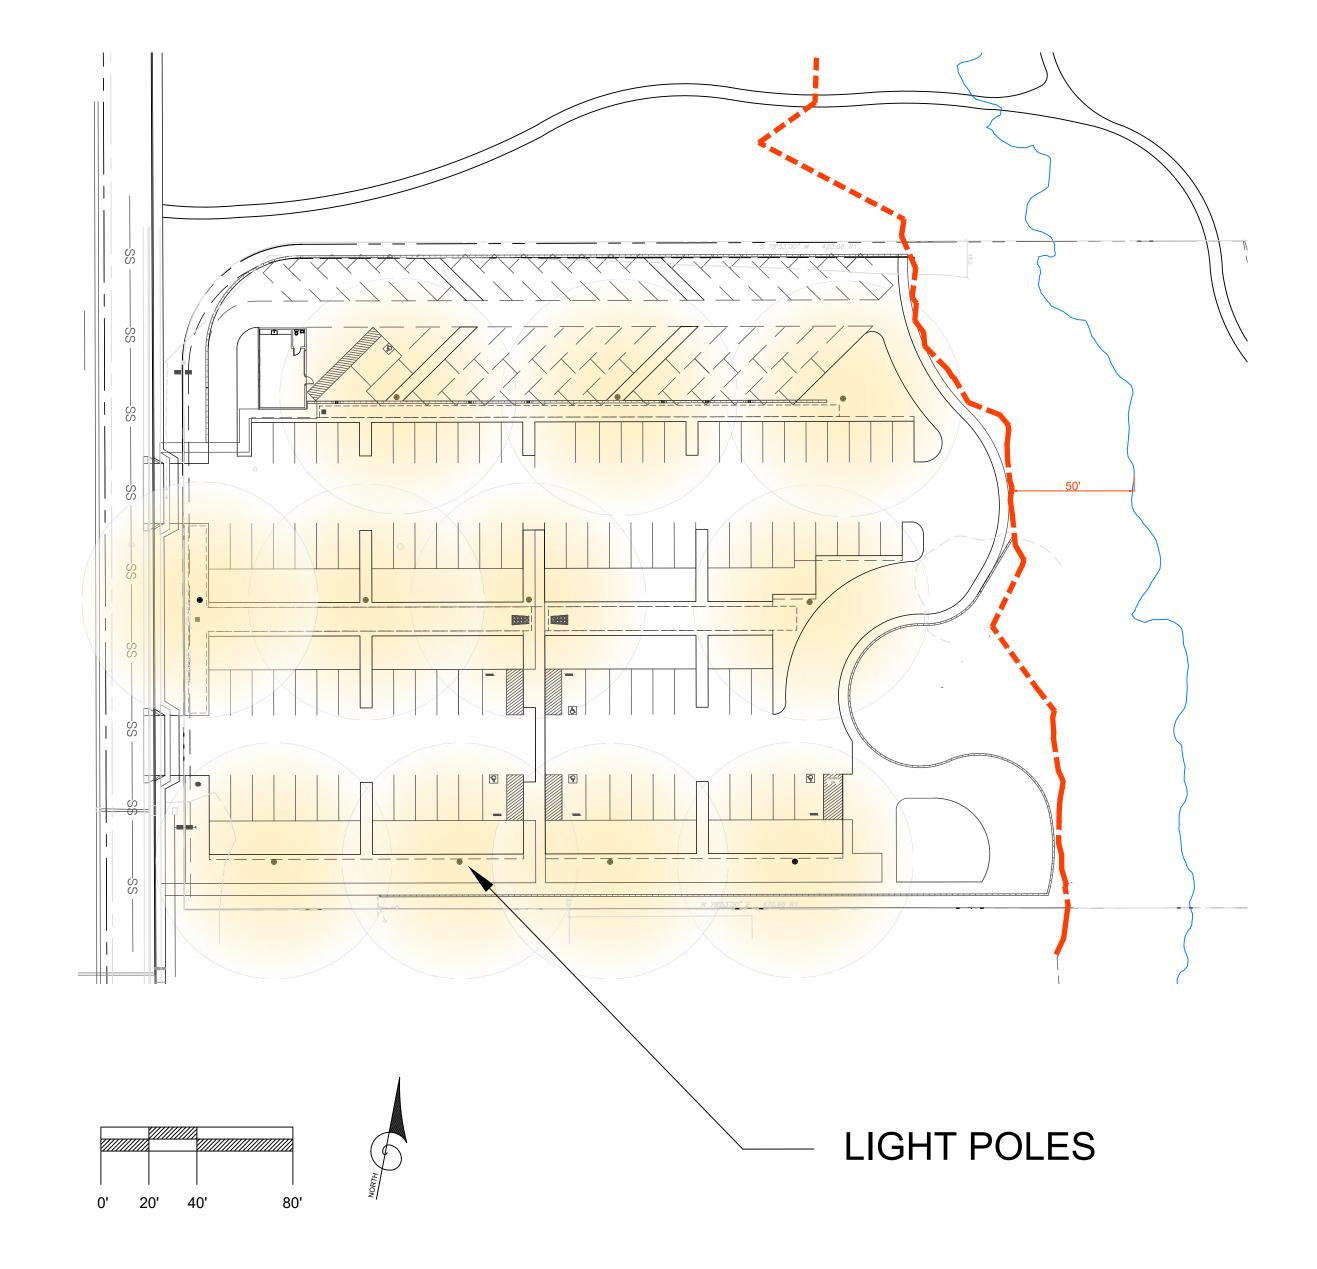



PHOTOMETRIC PLAN TO FOLLOW

- FIXTURE LAYOUT MAY BE ADJUSTED PER PHOTOMETRIC REVIEW





- E-EF LUMINAIRES = CONSIDER THE NIGHT ENVIRONMENT + INUNDATED SITES
   WE-EF LIGHTING
- POLE LIGHT-PFL540 LED -

IP66. Class I. IK08. Marine-grade, die-cast aluminum alloy. 5CE superior corrosion protection including PCS hardware. Silicone CCG® Controlled Compression Gasket. RFC® Reflection Free Contour main lens. CAD-optimized optics for superior illumination and glare control. Integral driver in thermally separated compartment. OLC® One LED Concept. Factory-installed LED circuit board. 0-10V Dimming comes standard with luminaire. The luminaire is factory-sealed, factory-wired and supplied with 33' of black, three conductor, flexible SEOW cord for power connection at pole-base hand hole.

WE-EF has a consistent focus on sustainability – from luminaires that are designed to last and environmentally-friendly production to the ultimate recycling as the majority of the materials used are recyclable. However, it is during their use that the luminaires have the greatest impact on the environment, due to the power they consume over the years and the way that light has a direct impact on people and nature. It is here that a paradigm shift is needed – greater awareness of the way that light is used at night.

WE-EF balances the non-visual, biological effects of light on humans as well as the impact on the natural environment, animals and plants, and the night sky.

WE-EF certified luminaires comply with Dark Sky. The luminaires are specifically designed to prevent user and installation errors such as incorrect alignment or orientation. Precision and minimizing stray light is a focus of the lighting.

The lighting luminaires enable light to be projected precisely and without stray light for impressive light effects, with a minimal impact on the environment.













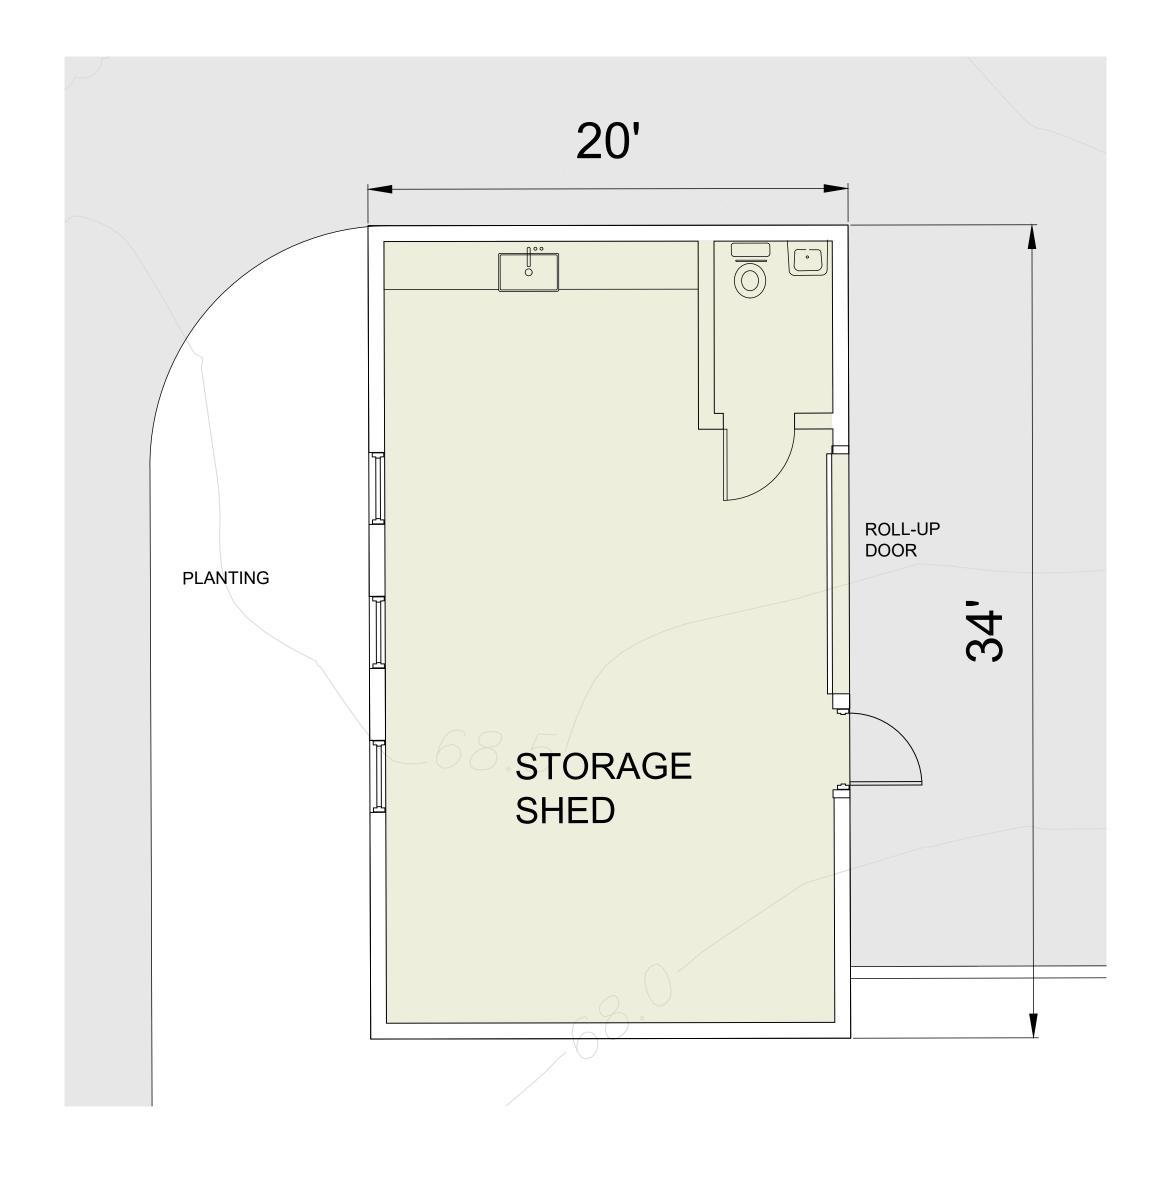

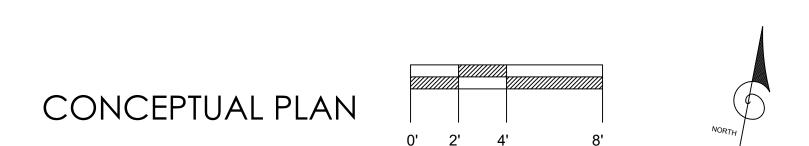







EAST ELEVATION

NOTE: ARCHITECTURAL STYLE AND MATERIALS TO MATCH THE BARLOW

**BATCH PLANT STORAGE SHED** 

L6.0








THE BARLOW HOTEL

DECEMBER 20, 2024

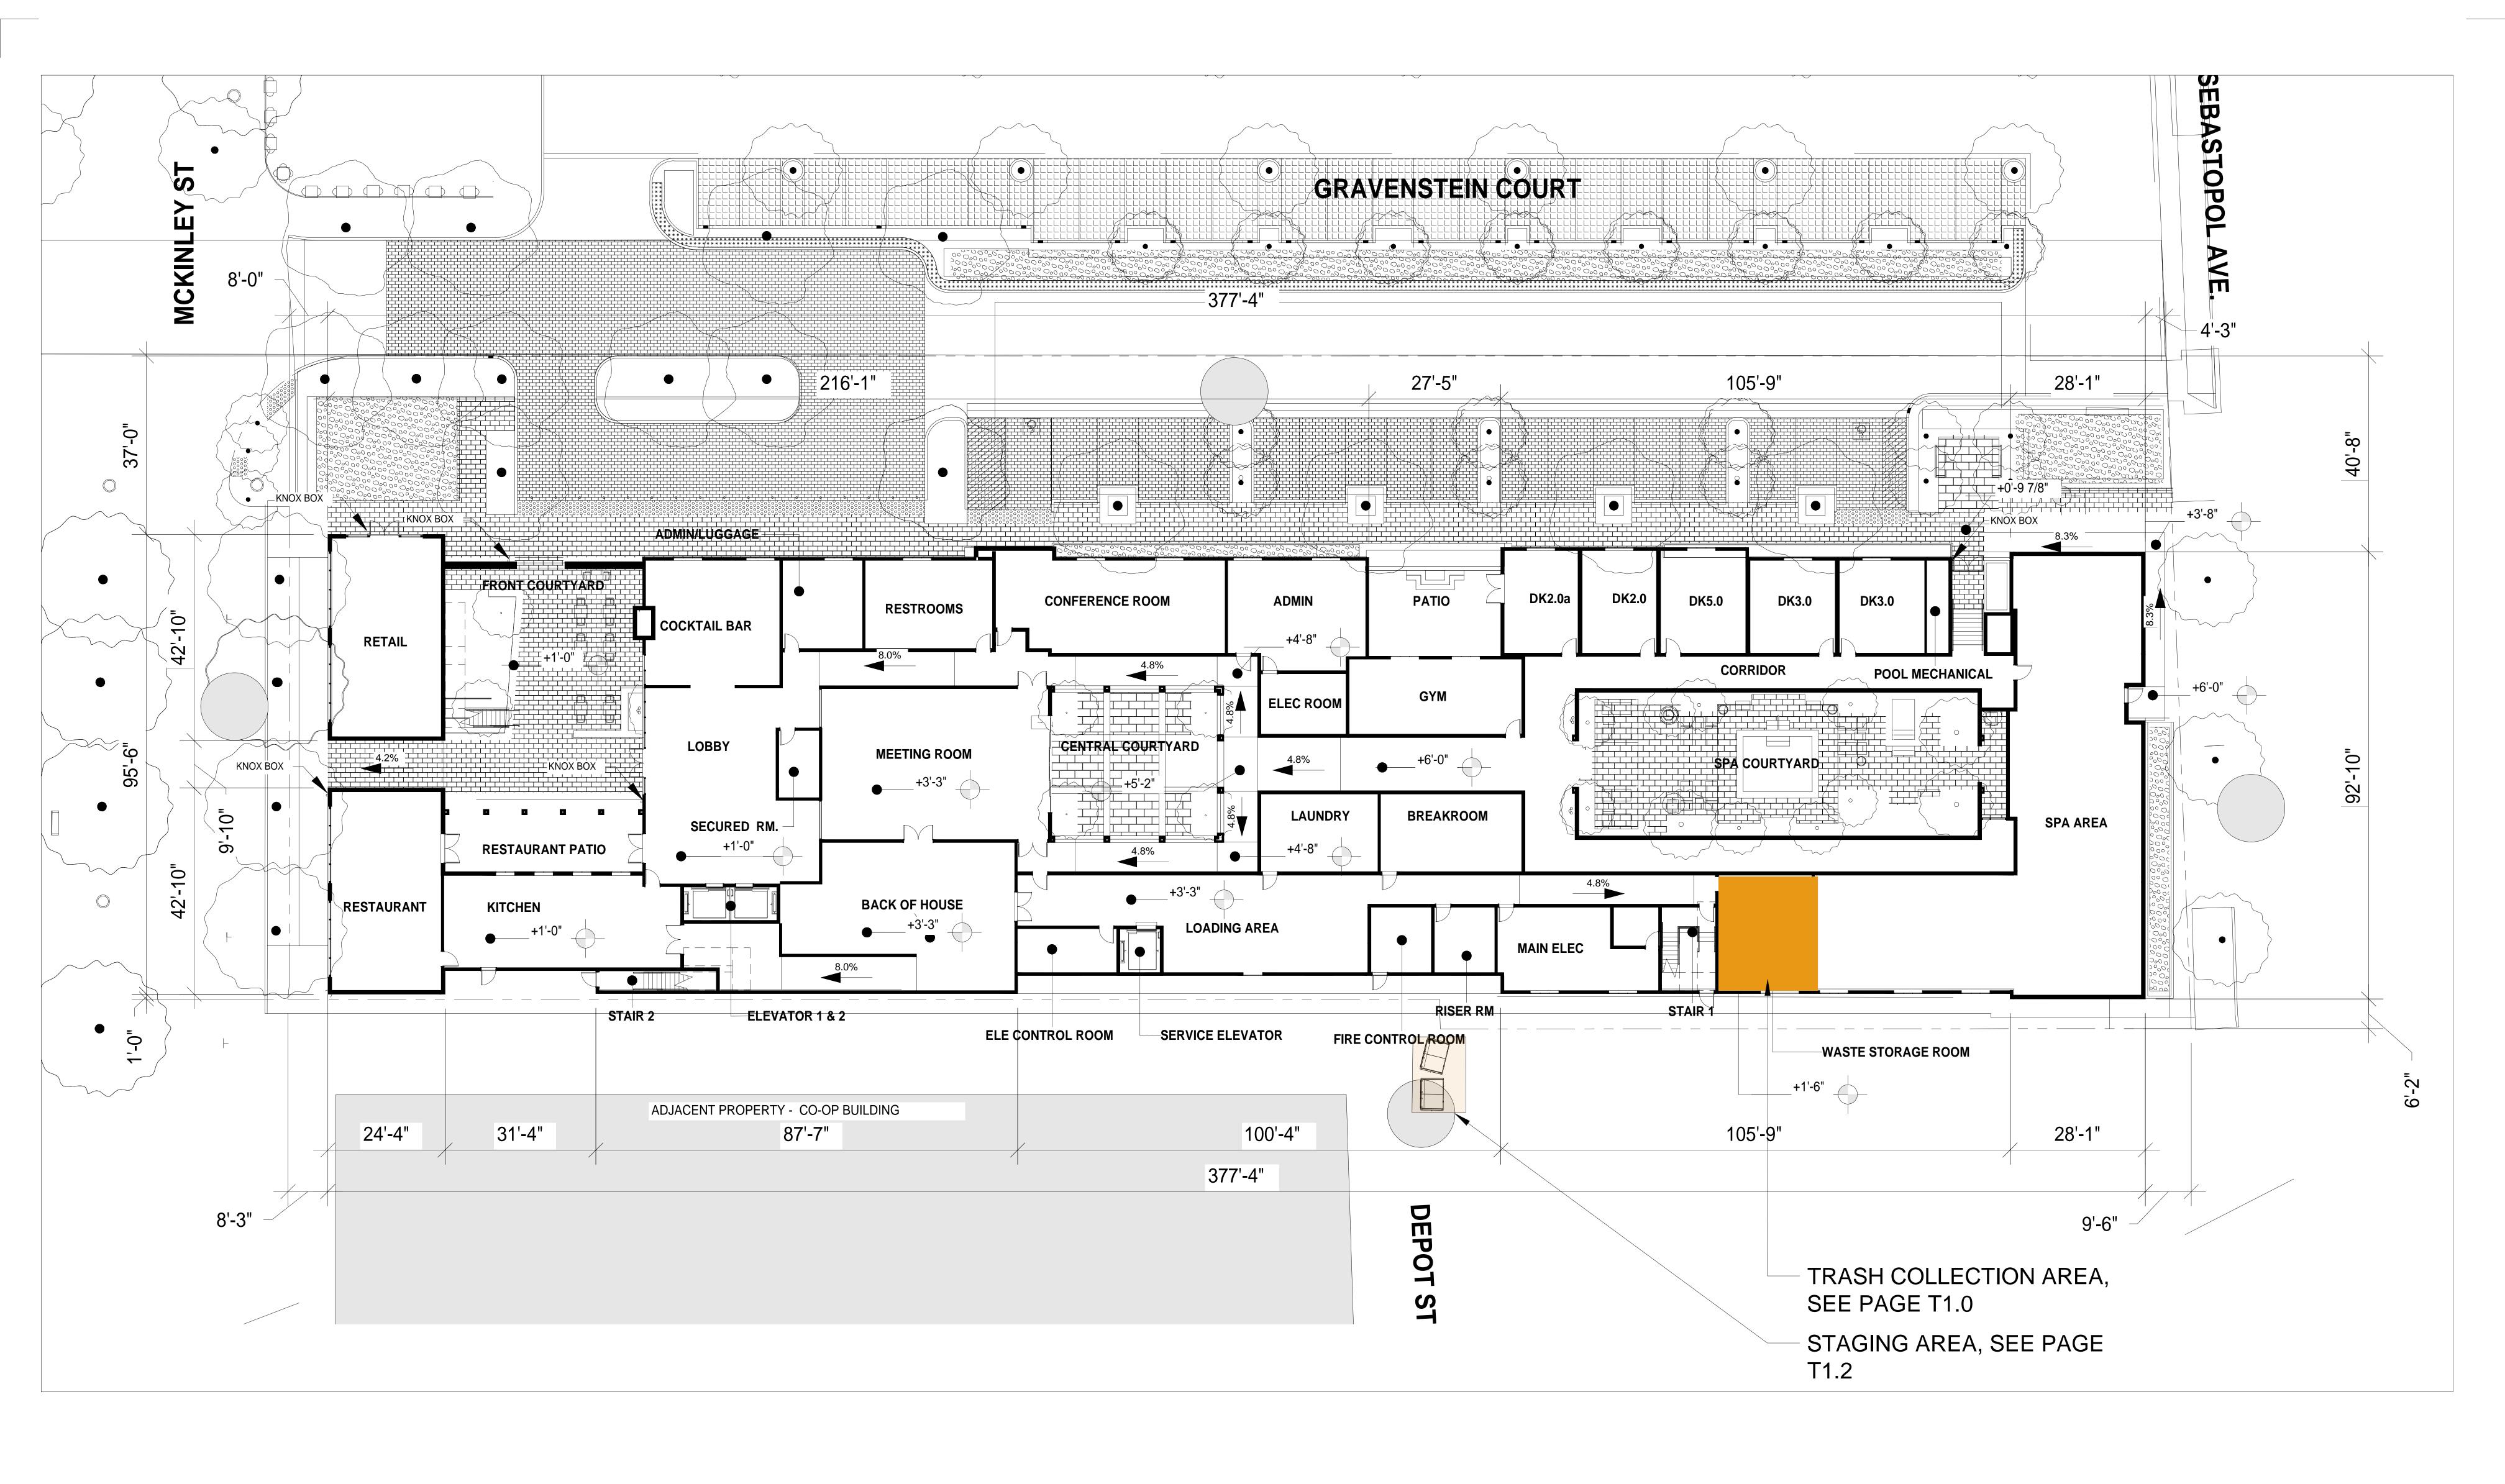

ARCHITECTURE






THE BARLOW HOTEL

T0.1

FLOOR 1 - PLAN

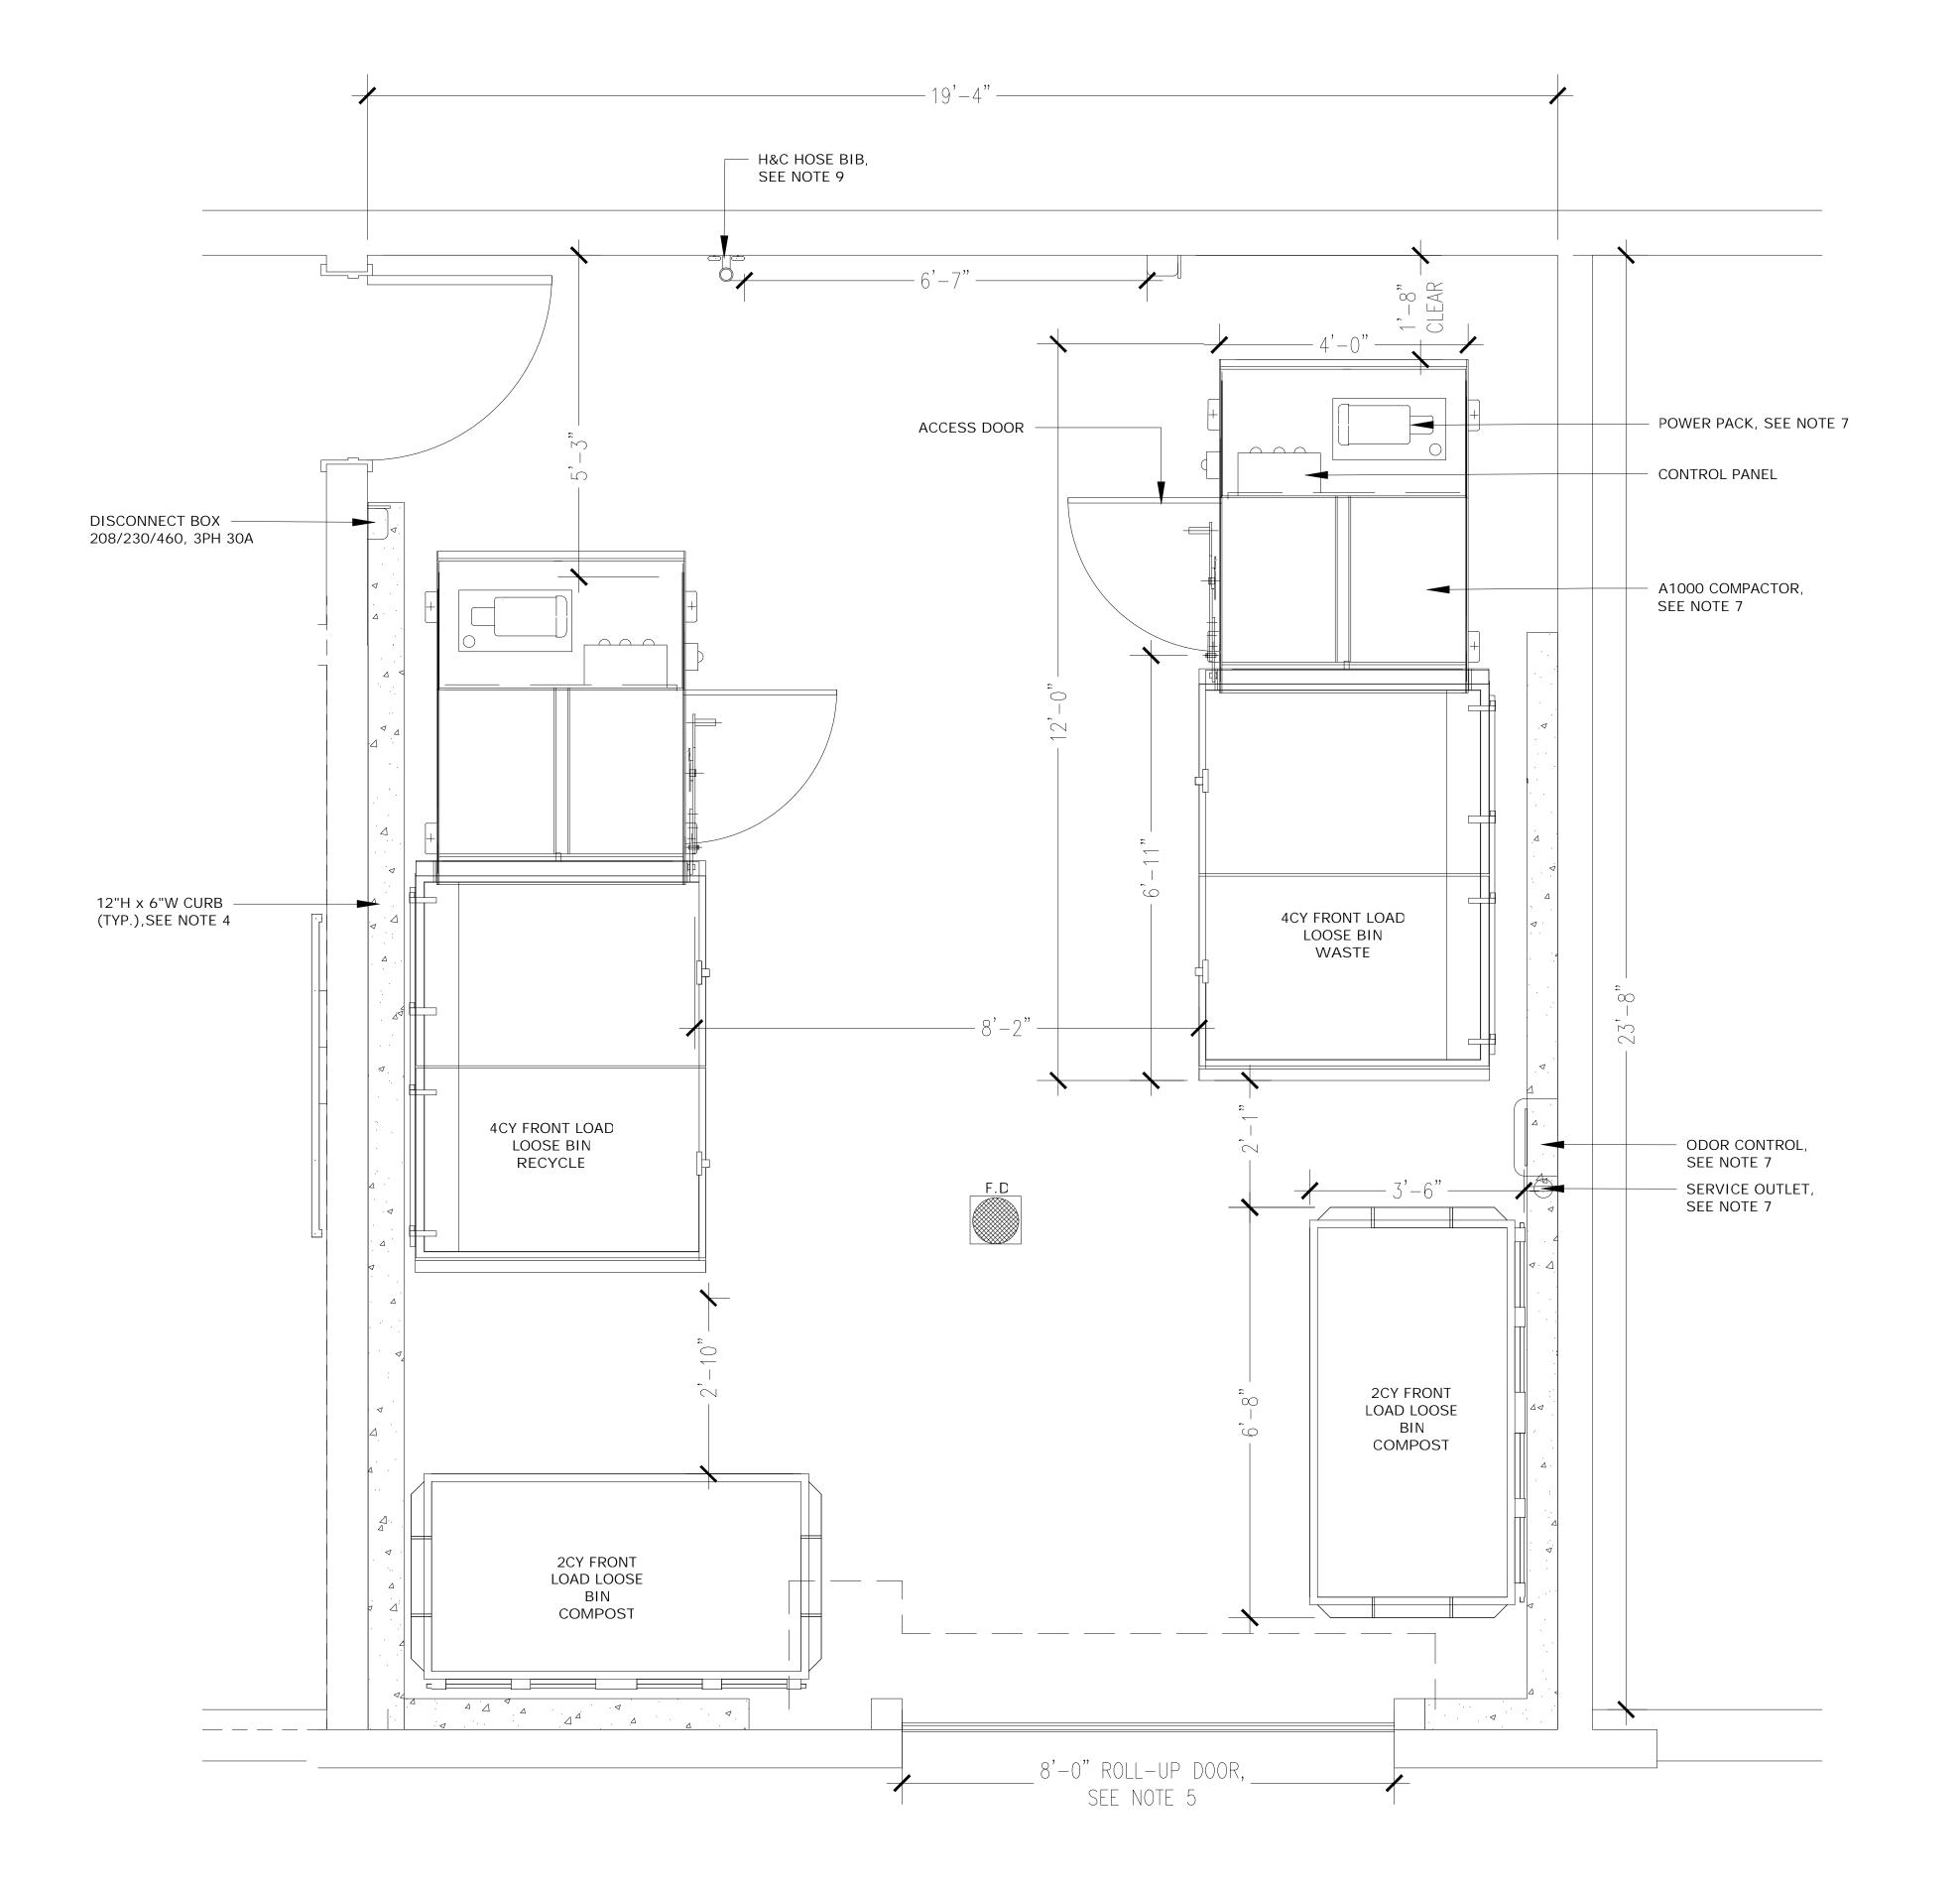



1/4"=1'-0"

T1.0





THE BARLOW HOTEL

SEBASTOPOL, CA

DECEMBER 20, 2024

**SHEET NOTES:** 

#### TRASH COLLECTION ROOM: LEVEL 1

- 1. TRASH COLLECTION ROOM IS A 2HR FIRE-RATED ROOM -RESTRICTED ACCESS
- 2. FLOOR SHALL BE FINISHED WITH ELASTO-DECK 6001 AL-HT DECK COATING. FLOOR TO HAVE MINIMAL SLOPE AND FLOOR DRAIN. FLOOR LEVEL UNDER COMPACTOR.
- 3. WALLS SHALL BE FINISHED WITH WASHABLE WATERPROOF SURFACE SUCH AS FRP OR HIGH-GLOSS ENAMEL PAINT, 8'-0"
- 4. INSTALL WALL PROTECTION: 12"H x 6"W CONCRETE CURB AT BASE OF ALL NON-CONCRETE WALLS.
- 5. 8'-0" ROLL UP DOOR AND 3'-0" ACCESS DOORS.
- 6. ROOM SHALL BE MECHANICALLY VENTILATED WITH (1)
- CFM/SQ.FT PER 2022 CBC. 7. (2) A1000 1CY COMPACTORS WITH INTERNAL POWER PACKS FOR WASTE AND RECYCLING. PROVIDE (2) 4CY COMPACTION
- CONTAINERS. (2) 2CY CONTAINERS FOR COMPOST 8. OC: ODOR CONTROL UNIT SHALL BE WALL-MOUNTED 60" AFF.
- 9. HB: HOT AND COLD HOSE BIBB SHALL BE WALL-MOUNTED 60"
- 10. PROVIDE ELECTRIC WASTE CADDY HD FOR TRANSFERRING TOWABLE CONTAINERS.
- 11. 120V, 15A SERVICE OUTLET REQUIRED FOR ALL EQUIPMENT (U.O.N.).


#### **GENERAL NOTES:**

- THIS DRAWINGS IS NOT DRAWN TO SCALE
- 2. ANY DESIGNS OR DESIGN SOLUTIONS PRESENTED IN THIS DRAWING OR SPECIFICATION, WHICH ARE DIRECT OR IMPLIED, INCLUDING NARRATIVES, DRAWINGS, OR DIAGRAMS, ARE HEREBY CLARIFIED AS EXAMPLES AND SHALL NOT BE CONSIDERED COMPLETE DESIGNS OR DESIGNS SUITABLE FOR CONSTRUCTION.
- 3. OMISSIONS FROM DRAWINGS OR SPECIFICATIONS, OR THE INACCURATE DESCRIPTION OF DETAILS OF WORK, WHICH ARE MANIFESTLY NECESSARY TO CARRY OUT THE INTENT OF THE CUSTOMARILY PERFORMED, CONTRACTOR FROM PERFORMING SUCH OMITTED OR INACCURATELY DESCRIBED DETAILS OF THE WORK. WORK SHALL BE PERFORMED AS IF FULLY AND CORRECTLY SET FORTH AND DESCRIBED IN THE DRAWINGS AND SPECIFICATIONS.
- 4. CONTRACTOR SHALL FIELD VERIFY ALL DIMENSIONS AND CONDITIONS PRIOR TO START OF CONSTRUCTION. THE ARCHITECT SHALL BE NOTIFIED IMMEDIATELY OF ALL EXISTING FIELD CONDITIONS AND ANY DISCREPANCIES OR INCONSISTENCIES.


ARCHITECTURE

ALDRIDGE DEVELOPMENT


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- 3. OMISSIONS FROM DRAWINGS OR SPECIFICATIONS, OR THE INACCURATE DESCRIPTION OF DETAILS OF WORK, WHICH ARE MANIFESTLY NECESSARY TO CARRY OUT THE INTENT OF THE DRAWINGS AND SPECIFICATIONS, OR WHICH ARE CUSTOMARILY PERFORMED, SHALL NOT RELIEVE THE CONTRACTOR FROM PERFORMING SUCH OMITTED OR INACCURATELY DESCRIBED DETAILS OF THE WORK. WORK SHALL BE PERFORMED AS IF FULLY AND CORRECTLY SET FORTH AND DESCRIBED IN THE DRAWINGS AND SPECIFICATIONS.
- CONTRACTOR SHALL FIELD VERIFY ALL DIMENSIONS AND CONDITIONS PRIOR TO START OF CONSTRUCTION. THE ARCHITECT SHALL BE NOTIFIED IMMEDIATELY OF ALL EXISTING FIELD CONDITIONS AND ANY DISCREPANCIES OR INCONSISTENCIES.

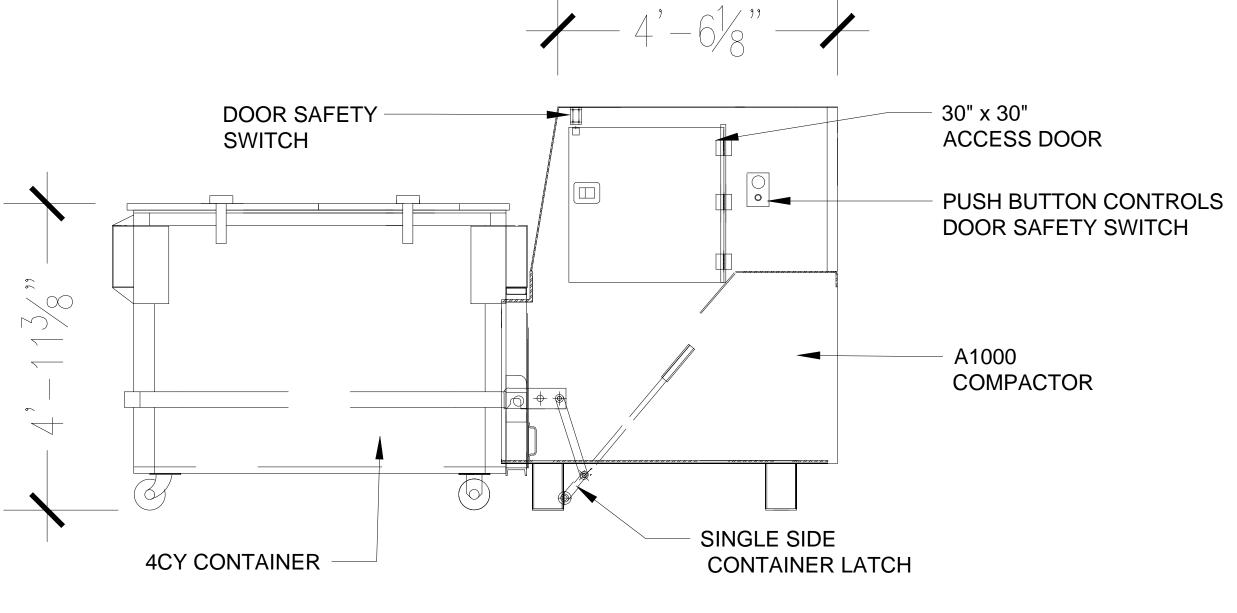


SIDE VIEW

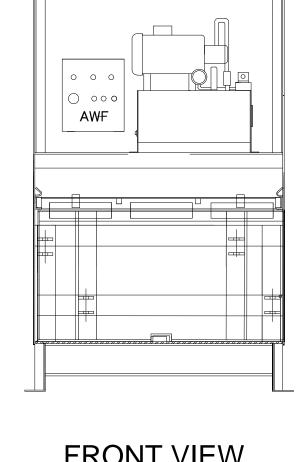




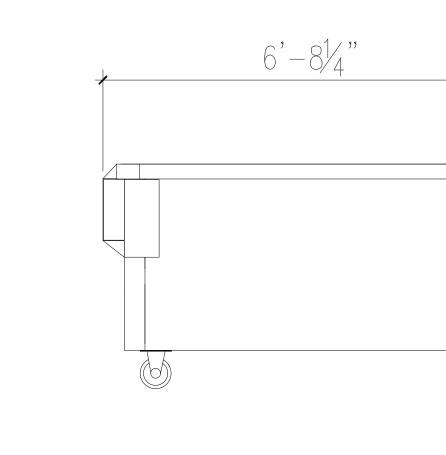

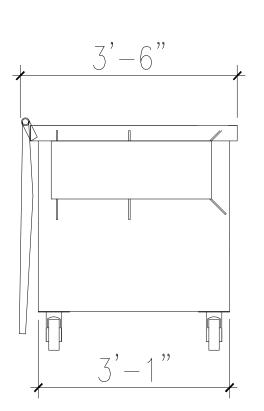

SIDE VIEW



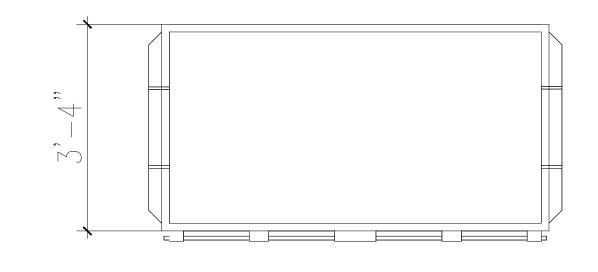

TOP VIEW

2CY LOOSE FRONT LOAD CONTAINER

ARCHITECTURE







APOLLO A-1000 H-F COMPACTOR DETAILS

THE BARLOW HOTEL


SEBASTOPOL, CA

**SECTIONS** 

DECEMBER 20, 2024

1/32"=1'-0"


T1.1

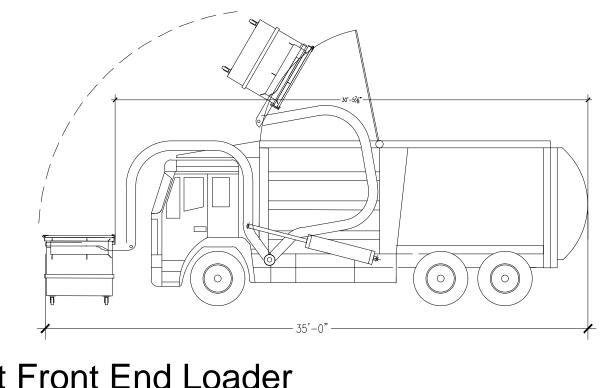

35ft Front End Loader Overall Length Overall Width Overall Body Height Min Body Ground Clearance Track Width Lock-to-lock time Curb to Curb Turning Radius

35.000ft 8.330ft 13.50ft 1.400ft 8.000ft 4.00s 32.000ft

### **FL TRUCK DIMENSIONS**

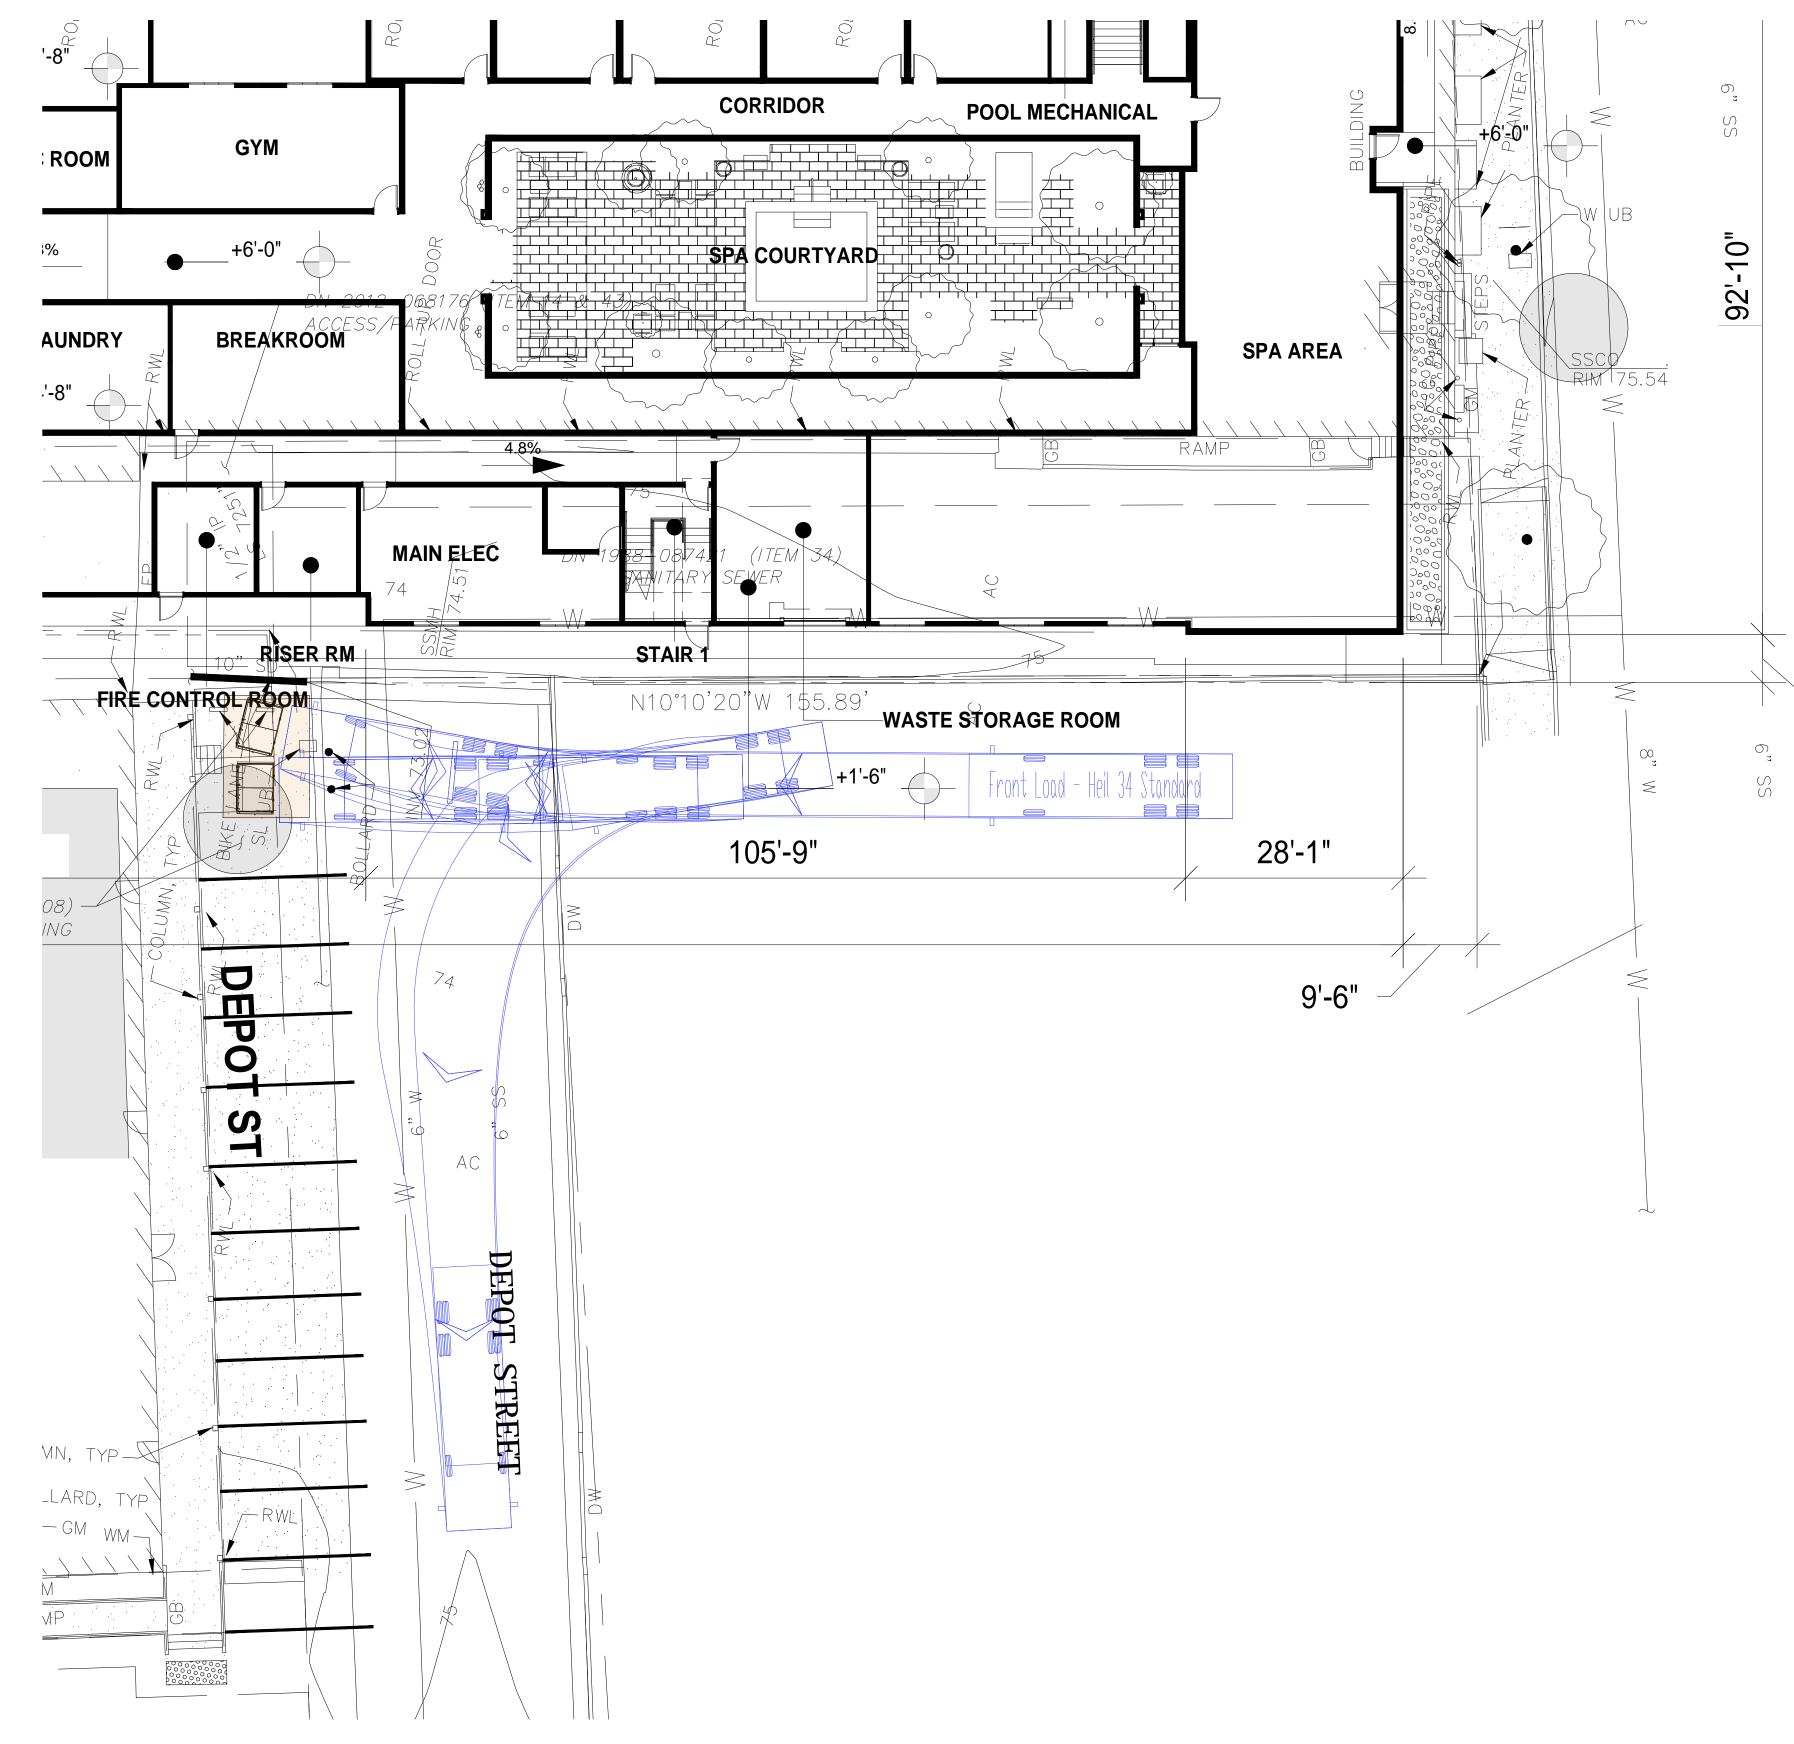

STAGING AREA- COMPACTED CONTAINERS

STAGING AREA

1/32"=1'-

T1.2

ARCHITECTURE





THE BARLOW HOTEL
SEBASTOPOL, CA
DECEMBER 20, 2024